9 MARCH 2023

SHEET INDEX				
Sheet Number		Sheet Name		
L000	COVER SHEET			
L100	SITE PLAN			
L101	PLAZA DEMOLITION PLAN			
L200	SITE MATERIALS PLAN			
L300	SITE LAYOUT PLAN			
L301	SITE PAVING PLAN			
L400	SITE GRADING PLAN			
L500	SITE FURNISHINGS PLAN			
L501	SITE LIGHTING AND OUTLET PLAN			
L600	SITE SOILS PLAN			
L620	DETAILS - SOILS			
L700	SITE SECTIONS & ELEVATIONS			
L800	DETAILS - PAVING			
L810	DETAILS - SITE WALLS - ELEVATIONS			
L811	DETAILS - SITE WALLS			
L820	DETAILS - SITE STAIRS / RAMPS			
L830	DETAILS - SITE FURNISHINGS			
L900	PLANTING PLAN			
L920	DETAILS - PLANTING			
L930	PLANTING SCHEDULE			

17 11	LANDSCAPE ABBREVIATIONS
Key Name AL	Comments ALUMINUM
AL	ANCHOR
& ANC	AND
L	ANGLE OR L-SHAPE
ASPH	ASPHALT
@	AT
AVG	AVERAGE
BC BETW	BEGINNING OF CURVE (ASSOCIATED WITH NORTHING/EASTING COORDINATES)
BYD	BETWEEN BEYOND
BS	BOTTOM OF STAIR
BW	BOTTOM OF WALL
BLDG	BUILDING
CIP	CAST IN PLACE
CTR	CENTER
CL	CENTERLINE
COS CLR	CITY OF SEATTLE CLEAR, CLEARANCE
CLR	CONCRETE MASONRY UNIT
CJ	CONSTRUCTION JOINT
CONT	CONTINUOUS
CJ	CONTROL JOINT
CRZ	CRITICAL ROOT ZONE
CF	CUBIC FEET
CY	CUBIC YARD
DTL DIA	DETAIL DIAMETER
DBH	DIAMETER AT BREAST HEIGHT
DIM	DIMENSION
DWG(S)	DRAWING(S)
EW	EACH WAY
Е	EAST, EASTING
EL	ELEVATION
E.O.C.	END OF CURVE (ASSOCIATED WITH NORTHING (EASTING COORDINATES)
EC EQ	END OF CURVE (ASSOCIATED WITH NORTHING/EASTING COORDINATES) EQUAL, EQUALIZATION
EX	EXISTING
EJ	EXPANSION JOINT
FOW	FACE OF WALL
FG	FINISH GRADE
FOIC	FURNISHED BY OWNER, INSTALLED BY CONTRACTOR
GAL	GALLON
GPM GALV	GALLONS PER MINUTE
HP	GALVANIZED HIGH POINT
IN	INCH (ES)
ID	INSIDE DIAMETER
IE	INVERT ELEVATION
JT	JOINT
JST	JOIST
LA	LANDSCAPE ARCHITECT
LH LOW	LEFT HAND LIMIT OF WORK
LF	LINEAR FEET
LP	LOW POINT
MFR	MANUFACTURER
MHHW	MEAN HIGH HIGH WATER
MLW	MEAN LOW WATER
MLLW NE	MEAN LOWER LOW WATER
	NORTHEAST
NW NIC	NORTHWEST NOT IN CONTRACT
NTC	NOT TO SCALE
NTS	NOT TO SCALE
OD	OUTSIDE DIAMETER
PKG	PACKAGE
POB	POINT OF INTERSECTION
PI POC	POINT OF INTERSECTION POINT ON CURVE
POC	POINT ON CURVE POINT, POINT OF TANGENCY
PSF	POUNDS FORCE PER SQUARE FOOT
PSI	POUNDS FORCE PER SQUARE INCH
QTY	QUANTITY
RAD	RADIUS
RC	REINFORCED CONCRETE
RH	RIGHT HAND
ROW RPZ	RIGHT OF WAY ROOT PROTECTION ZONE
SCH	SCHEDULE SCHEDULE
SEC	SECTION
SPEC	SPECIFICATIONS
SQ	SQUARE
SF	SQUARE FOOT
SSTL	STAINLESS STEEL
STL	STEEL
T.O. TB	TOP OF TOP OF BENCH
TOC	TOP OF BENCH TOP OF CONCRETE
TC	TOP OF CONCRETE TOP OF CURB
TOG	TOP OF GRATING
TS	TOP OF STAIR
TW	TOP OF WALL
TYP	TYPICAL
VIF	VERIFY IN FIELD
VERT	VERTICAL WIDE ELANCE
WF W/	WIDE FLANGE WITH
	WITHOUT
W/O	WITHOUT

Perkins&Will

225 Franklin Street, Suite 1100 Boston, MA 02110 t 617.478.0300 f 617.478.0321 www.perkinswill.com

Jensen Hughes
One Lincoln Street
Boston, MA 02111
t 1-508-273-8481

Bohler Engineers
45 Franklin Street
Boston, MA 02110
t 617-478-0300

LANDSCAPE ARCHITECT
PERKINS&WILL
225 Franklin Street, Suite 1100
Boston, MA 02110
t 617.478.0300
f 617.478.0321

LANDSCAPE CONSULTANT MCLV 524 Walnut St. #330 Kansas City, MO 64106 t816-945-4119

SUSTAINABILITY CONSULTANT
The Green Engineer
23 Bradford Street

Concord, MA 01742 t 978-341-5462 structural RFS Engineering

50 Milk Street Boston, MA 02109

t 617-494-1464

MEP/FP

RFS Engineering

50 Milk Street

Boston, MA 02109

t 617-494-1464

PROJECT



Davis Square Plaza


0


ASANA PARTNERS


1616 Camden Road Suite 210

Charlotte, NC 28203

KEYPLAN

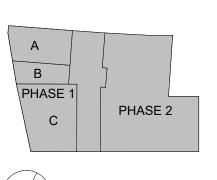

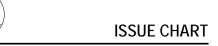


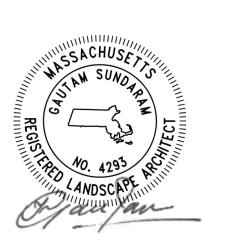

Job Number 2206

COVER SHEET

SHEET NUMBER

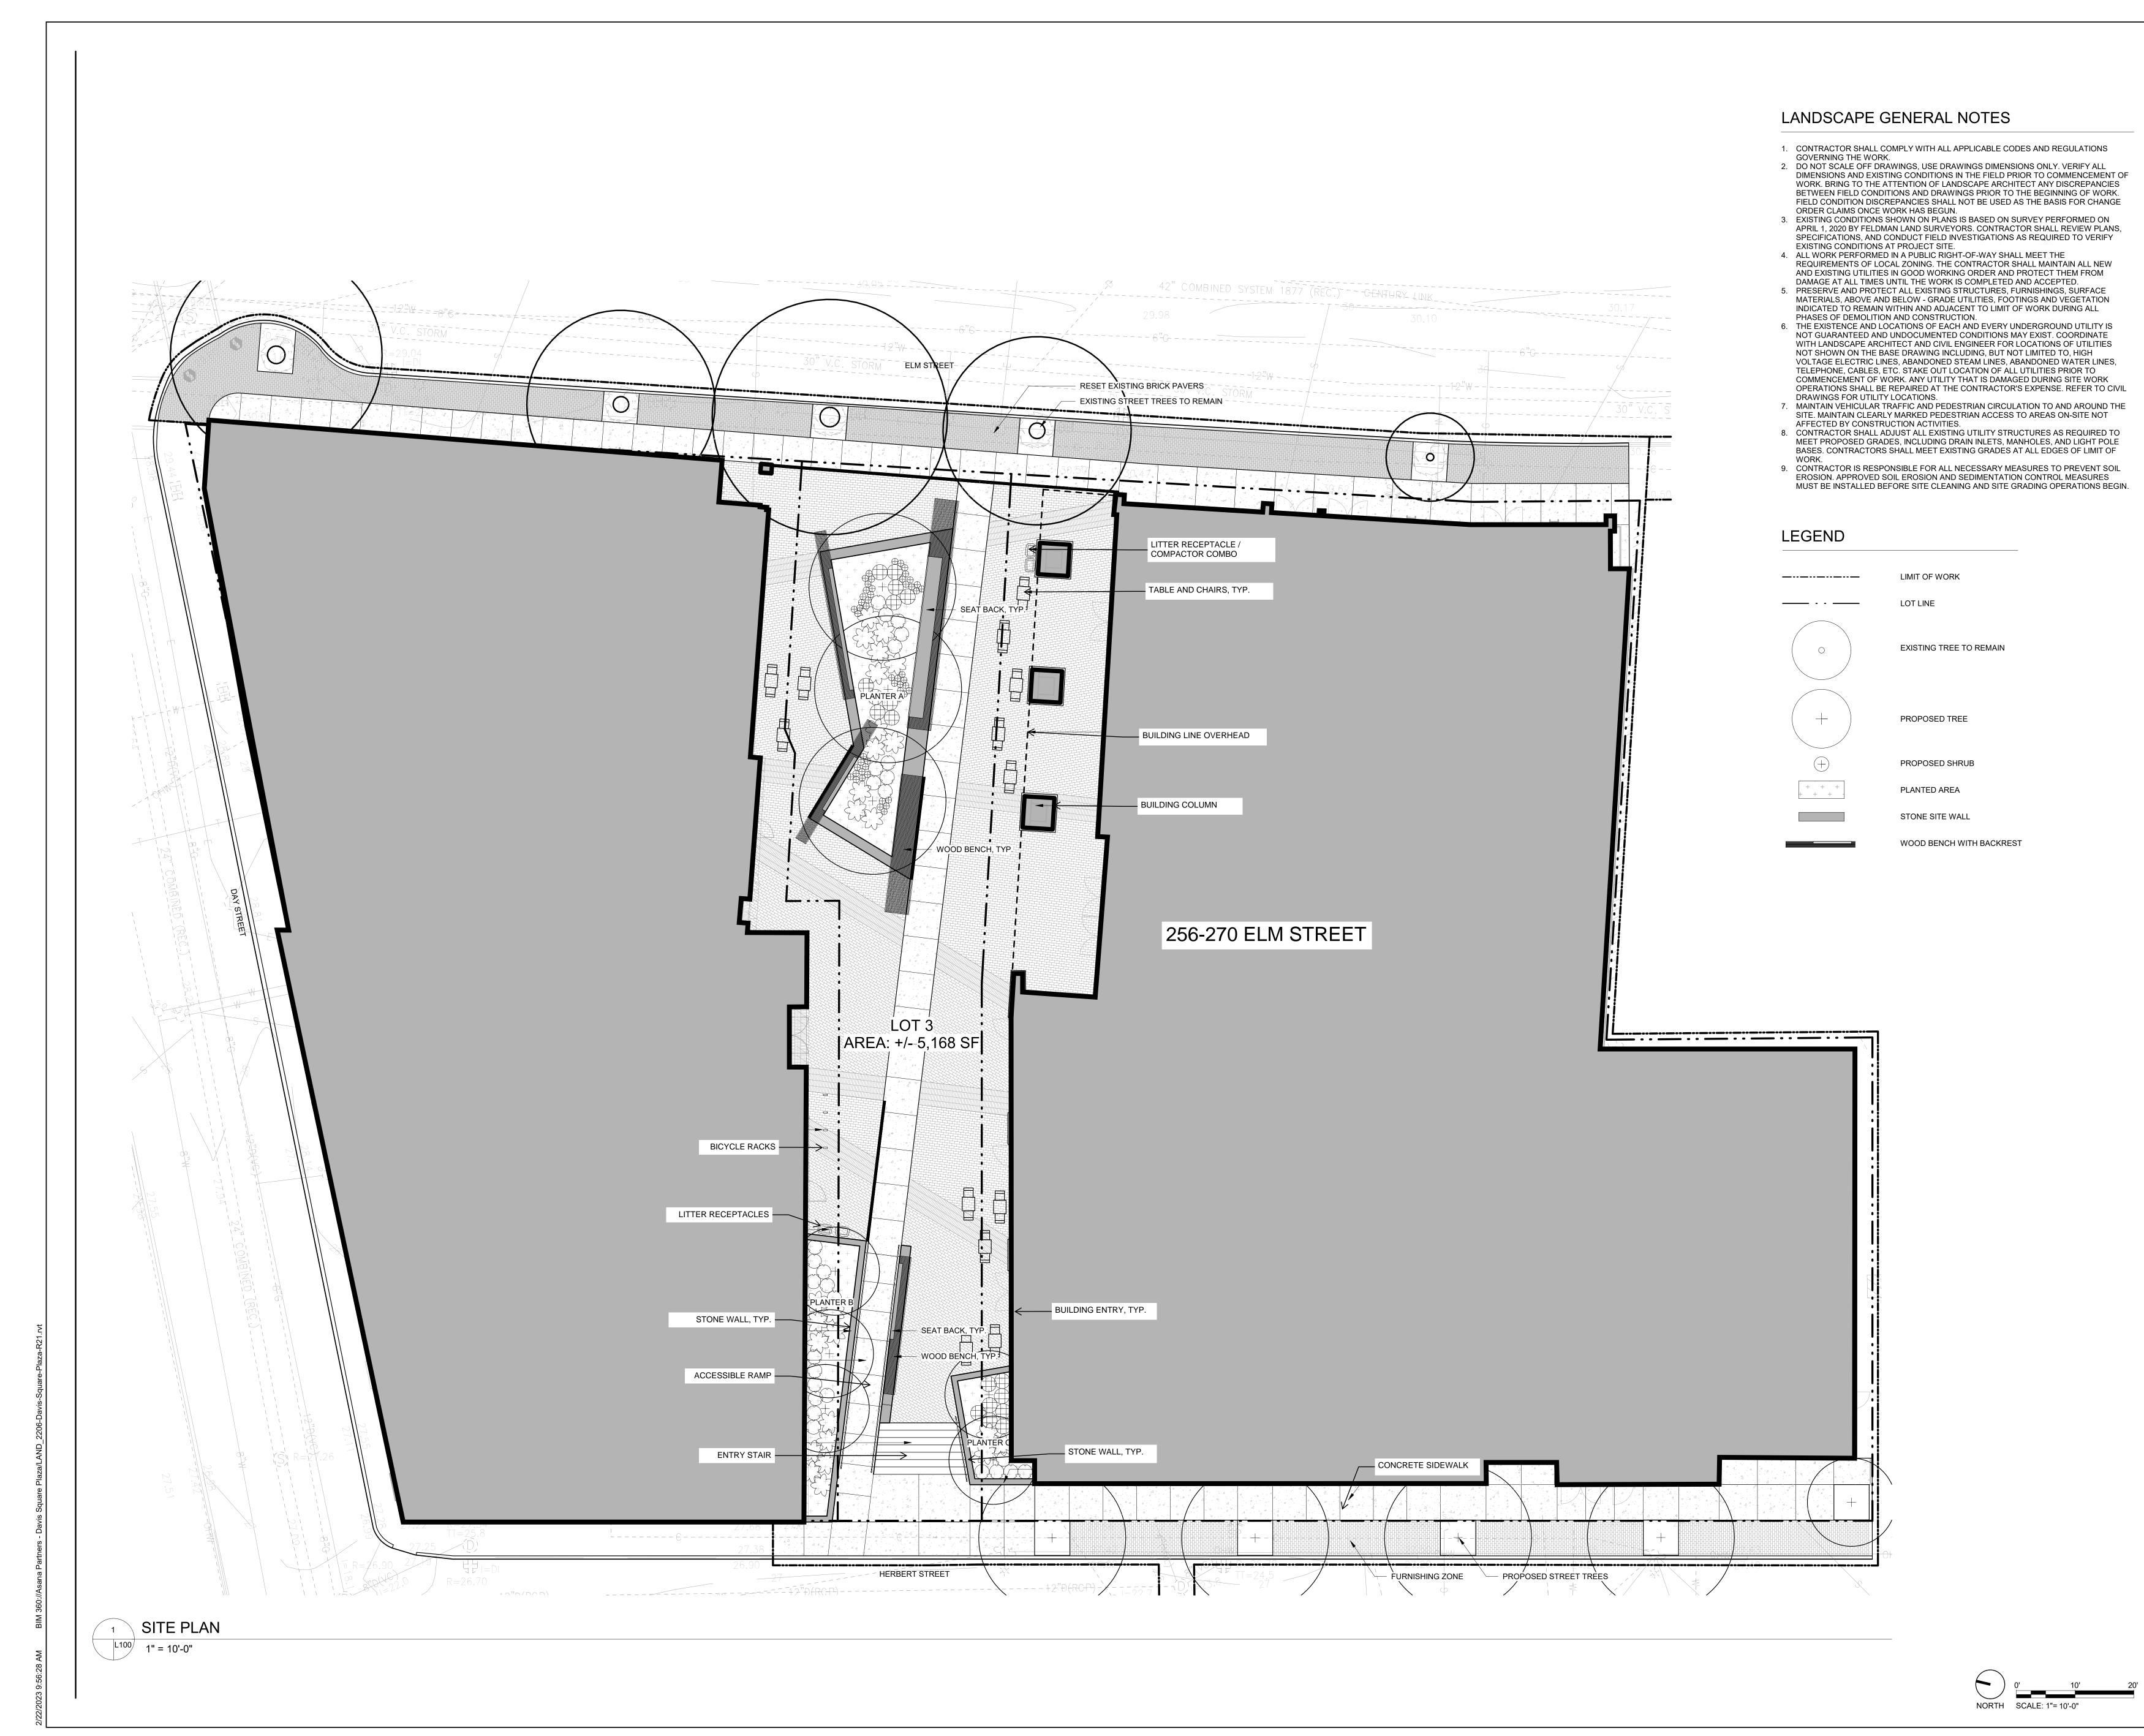

225 Franklin Street, Suite 1100 Boston, MA 02110 t 617.478.0300 f 617.478.0321 www.perkinswill.com

Jensen Hughes
One Lincoln Street
Boston, MA 02111
t 1-508-273-8481

Bohler Engineers 45 Franklin Street Boston, MA 02110 t 617-478-0300

LANDSCAPE ARCHITECT
PERKINS&WILL
225 Franklin Street, Suite 1100
Boston, MA 02110
t 617.478.0300
f 617.478.0321

LANDSCAPE CONSULTANT
MCLV
524 Walnut St. #330
Kansas City, MO 64106

sustainability consultant The Green Engineer

t816-945-4119

23 Bradford Street Concord, MA 01742 t 978-341-5462

STRUCTURAL
RFS Engineering
50 Milk Street
Boston, MA 02109
t 617-494-1464

MEP/FP RFS Engineering 50 Milk Street Boston, MA 02109 t 617-494-1464

PROJECT



Davis Square Plaza


(0)

ASANA PARTNERS

1616 Camden Road Suite 210

Charlotte, NC 28203

KEYPLAN

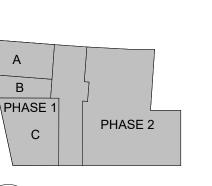

ISSUE CHART



SITE PLAN

SHEET NUMBER



- DIMENSIONS AND EXISTING CONDITIONS IN THE FIELD PRIOR TO COMMENCEMENT OF
- AREA DRAINS, AND ASSOCIATED UNDERGROUND PIPING WITHIN THE LIMIT OF WORK. DETERMINE IF THE CATCH BASINS ARE LEACHING STRUCTURES AND FULLY REMOVE

DEPTH. REMOVE ALL ELEMENTS INCLUDING BUT NOT LIMITED TO SIGNAGE, RAILINGS, FENCES, AND DRAINS. SEE NOTES ABOVE.

PROJECT



Davis Square Plaza

Perkins&Will

225 Franklin Street, Suite 1100

Boston, MA 02110

www.perkinswill.com

Jensen Hughes

One Lincoln Street

Boston, MA 02111

t 1-508-273-8481

Bohler Engineers

45 Franklin Street

Boston, MA 02110

LANDSCAPE CONSULTANT

524 Walnut St. #330

Kansas City, MO 64106 t816-945-4119

SUSTAINABILITY CONSULTANT

23 Bradford Street

t 978-341-5462

50 Milk Street

t 617-494-1464

50 Milk Street

t 617-494-1464

Boston, MA 02109

Boston, MA 02109

RFS Engineering

Concord, MA 01742

RFS Engineering

The Green Engineer

t 617-478-0300

MCLV


t 617.478.0300

f 617.478.0321

ASANA PARTNERS **ASANA PARTNERS**

1616 Camden Road Suite 210 Charlotte, NC 28203

KEYPLAN

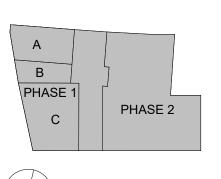

ISSUE CHART



PLAZA DEMOLITION

SHEET NUMBER

LEGEND -----**ELM STREET** UNIT PAVER TYPE 3 - SEE 3 / L800 4 / L800 GRAVEL EDGE - SEE 8 / L800 BUILDING LINE OVERHEAD LINEAR DRAIN- SEE L400 BUILDING COLUMN 256-270 ELM STREET LINEAR DRAIN- SEE L400 _ BUILDING ENTRY, TYP. HERBERT STREET MATERIALS PLAN L200 1" = 10'-0"

MATERIALS PLAN NOTES

- 1. CONTRACTOR TO NOTIFY LANDSCAPE ARCHITECT OF ANY DISCREPANCIES BETWEEN THE PLANS AND THE EXISTING CONDITIONS BEFORE STARTING WORK.
- 2. SEE L800 FOR MATERIAL DETAILS. 3. EXPANSION AND CONTROL JOINTS TO BE LAID OUT FOR REVIEW BY LANDSCAPE ARCHITECT. WORK SHALL NOT BEGIN UNTIL LAYOUT APPROVAL BY LANDSCAPE
- A. CONCRETE PAVEMENT CONTROL JOINTS TYPICALLY SPACED 12'x12', UNLESS SHOWN OTHERWISE. 4. REFER TO SPECIFICATIONS PERTAINING TO THE SPECIFIC MATERIALS TO BE USED FOR ALL TEMPORARY AND FINISH WORK.

LIMIT OF WORK PLANTED AREA - SEE L900 SERIES CONCRETE PAVING - SEE CIVIL CONCRETE PAVING - LANDSCAPE ARCHITECTURAL FINISH - SEE 1 / L800 UNIT PAVER TYPE 1 - SEE 2 / L800 4 / L800 UNIT PAVER TYPE 2 - SEE 2 / L800 5 / L800

BRICK PAVER - RESET EXISTING PAVERS - SEE CIVIL DOCUMENTATION

STONE TYPE 1 STONE TYPE 2

UTILITY COVER, TYPE (X) - SEE 7 / L800

PROJECT



Perkins&Will

225 Franklin Street, Suite 1100

Boston, MA 02110

www.perkinswill.com

Jensen Hughes

One Lincoln Street Boston, MA 02111 t 1-508-273-8481

Bohler Engineers 45 Franklin Street

Boston, MA 02110 t 617-478-0300

LANDSCAPE CONSULTANT

524 Walnut St. #330 Kansas City, MO 64106

sustainability consultant The Green Engineer

23 Bradford Street Concord, MA 01742 t 978-341-5462

RFS Engineering

RFS Engineering

50 Milk Street Boston, MA 02109 t 617-494-1464

50 Milk Street Boston, MA 02109 t 617-494-1464

t816-945-4119

MCLV

t 617.478.0300


f 617.478.0321



ASANA PARTNERS

1616 Camden Road Suite 210 Charlotte, NC 28203

KEYPLAN

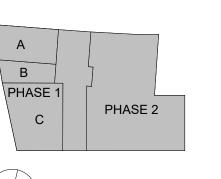

ISSUE CHART



SITE MATERIALS

SHEET NUMBER

LAYOUT PLAN NOTES 1. SITE SURVEY WAS PREPARED BY FELDMAN LAND SURVEYORS ON APRIL 1, 2020. ALL COORDINATES SHOWN ON THE DRAWINGS ARE BASED UPON THE COORDINATE SYSTEM ESTABLISHED BY THE SURVERYOR. MCLV ASSUMES NO RESPONSIBILITY FOR ACCURACY OF SURVEYED CONDITIONS AS SHOWN. SURVEY INFORMATION IS PROVIDED FOR REFERENCE ONLY. 2. DO NOT SCALE FROM THE DRAWINGS. THE LOCATION OF FEATURES NOT SPECIFICALLY DIMENSIONED MAY NOT BE DETERMINED BY SCALE. IF CONFLICTS ARISE IN THE FIELD, CONTACT LANDSCAPE ARCHITECT FOR RESOLUTION. A. ALL DIMENSIONS ARE TO THE OUTSIDE FACE OF BUILDINGS AND WALLS OR BACK OF CURBS, UNLESS OTHERWISE NOTED. B. ALL LINES AND DIMENSIONS ARE PARALLEL OR PERPENDICULAR TO THE LINES FROM WHICH THEY ARE MEASURED UNLESS OTHERWISE NOTED. C. ALL CURVED OBJECTS SHALL HAVE SMOOTH, CONTINUOUS CURVES WITH CONSISTENT RADII AS INDICATED. EACH CURVE SHALL MEET ADJACENT CURVES OR LINEAR SECTIONS ON THE TANGENT, UNLESS NOTED OTHERWISE. 3. CONTRACTOR SHALL VERIFY ALL EXISTING CONDITIONS AND LAYOUT DIMENSIONS IN THE FIELD AND REPORT ANY DISCREPANCIES TO LANDSCAPE ARCHITECT FOR DECISION PRIOR TO STARTING CONSTRUCTION. 4. CONTRACTOR SHALL CONTACT THE LANDSCAPE ARCHITECT IF THERE IS ANY CONFLICT BETWEEN THE COORDINATE POINTS AND DIMENSIONS WHEN LAYING OUT IN THE FIELD. 5. CONTRACTOR SHALL STAKE OR FLAG ALL SITE ELEMENTS TO BE CONSTRUCTED IN THE FIELD FOR APPROVAL BY LANDSCAPE ARCHITECT PRIOR TO CONSTRUCTION. 6. THE LANDSCAPE ARCHITECT MAY MAKE MINOR ADJUSTMENTS TO THE HORIZONTAL AND VERTICAL LAYOUT WITHOUT INCURRING ADDITIONAL COSTS TO THE PROJECT. ELM STREET — EXISTING TREE, TYP. LEGEND ALIGN ----- LIMIT OF WORK __ _ _ _ CENTERLINE EXPANSION JOINT - SEE 9 / L800 SCORE JOINT ←--PARALLEL ALIGN ANGLE POINT BASELINE BENCH MARK BEARING COORDINATE DEGREE DIAMETER EASEMENT LINE BUILDING LINE OVERHEAD FACE OF CURB FACE OF WALL LENGTH OF CURVE LONG CHORD LENGTH BUILDING COLUMN ON CENTER POINT OF BEGINNING POINT OF CURVATURE POINT OF COMPOUND CURVATURE POINT OF REVERSE CURVATURE POINT OF INTERSECTION POINT OF TANGENCY 256-270 ELM STREET SPACES SURVEY LINE TANGENT LENGTH VERIFY IN FIELD HERBERT STREET LAYOUT PLAN L300 1" = 10'-0"

Perkins&Will

225 Franklin Street, Suite 1100 Boston, MA 02110 t 617.478.0300 f 617.478.0321 www.perkinswill.com

> Jensen Hughes One Lincoln Street Boston, MA 02111 t 1-508-273-8481

CIVIL Bohler Engineers 45 Franklin Street Boston, MA 02110 t 617-478-0300

LANDSCAPE CONSULTANT MCLV 524 Walnut St. #330 Kansas City, MO 64106 t816-945-4119

sustainability consultant The Green Engineer 23 Bradford Street Concord, MA 01742

t 978-341-5462

structural
RFS Engineering

50 Milk Street

t 617-494-1464

MEP/FP
RFS Engineering
50 Milk Street

Boston, MA 02109

50 Milk Street Boston, MA 02109 t 617-494-1464

PROJECT



Davis Square Plaza




ASANA PARTNERS

1616 Camden Road Suite 210


Charlotte, NC 28203

KEYPLAN

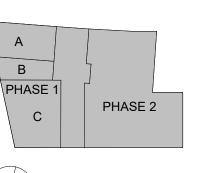






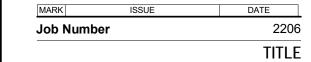

SITE LAYOUT PLAN

SHEET NUMBER

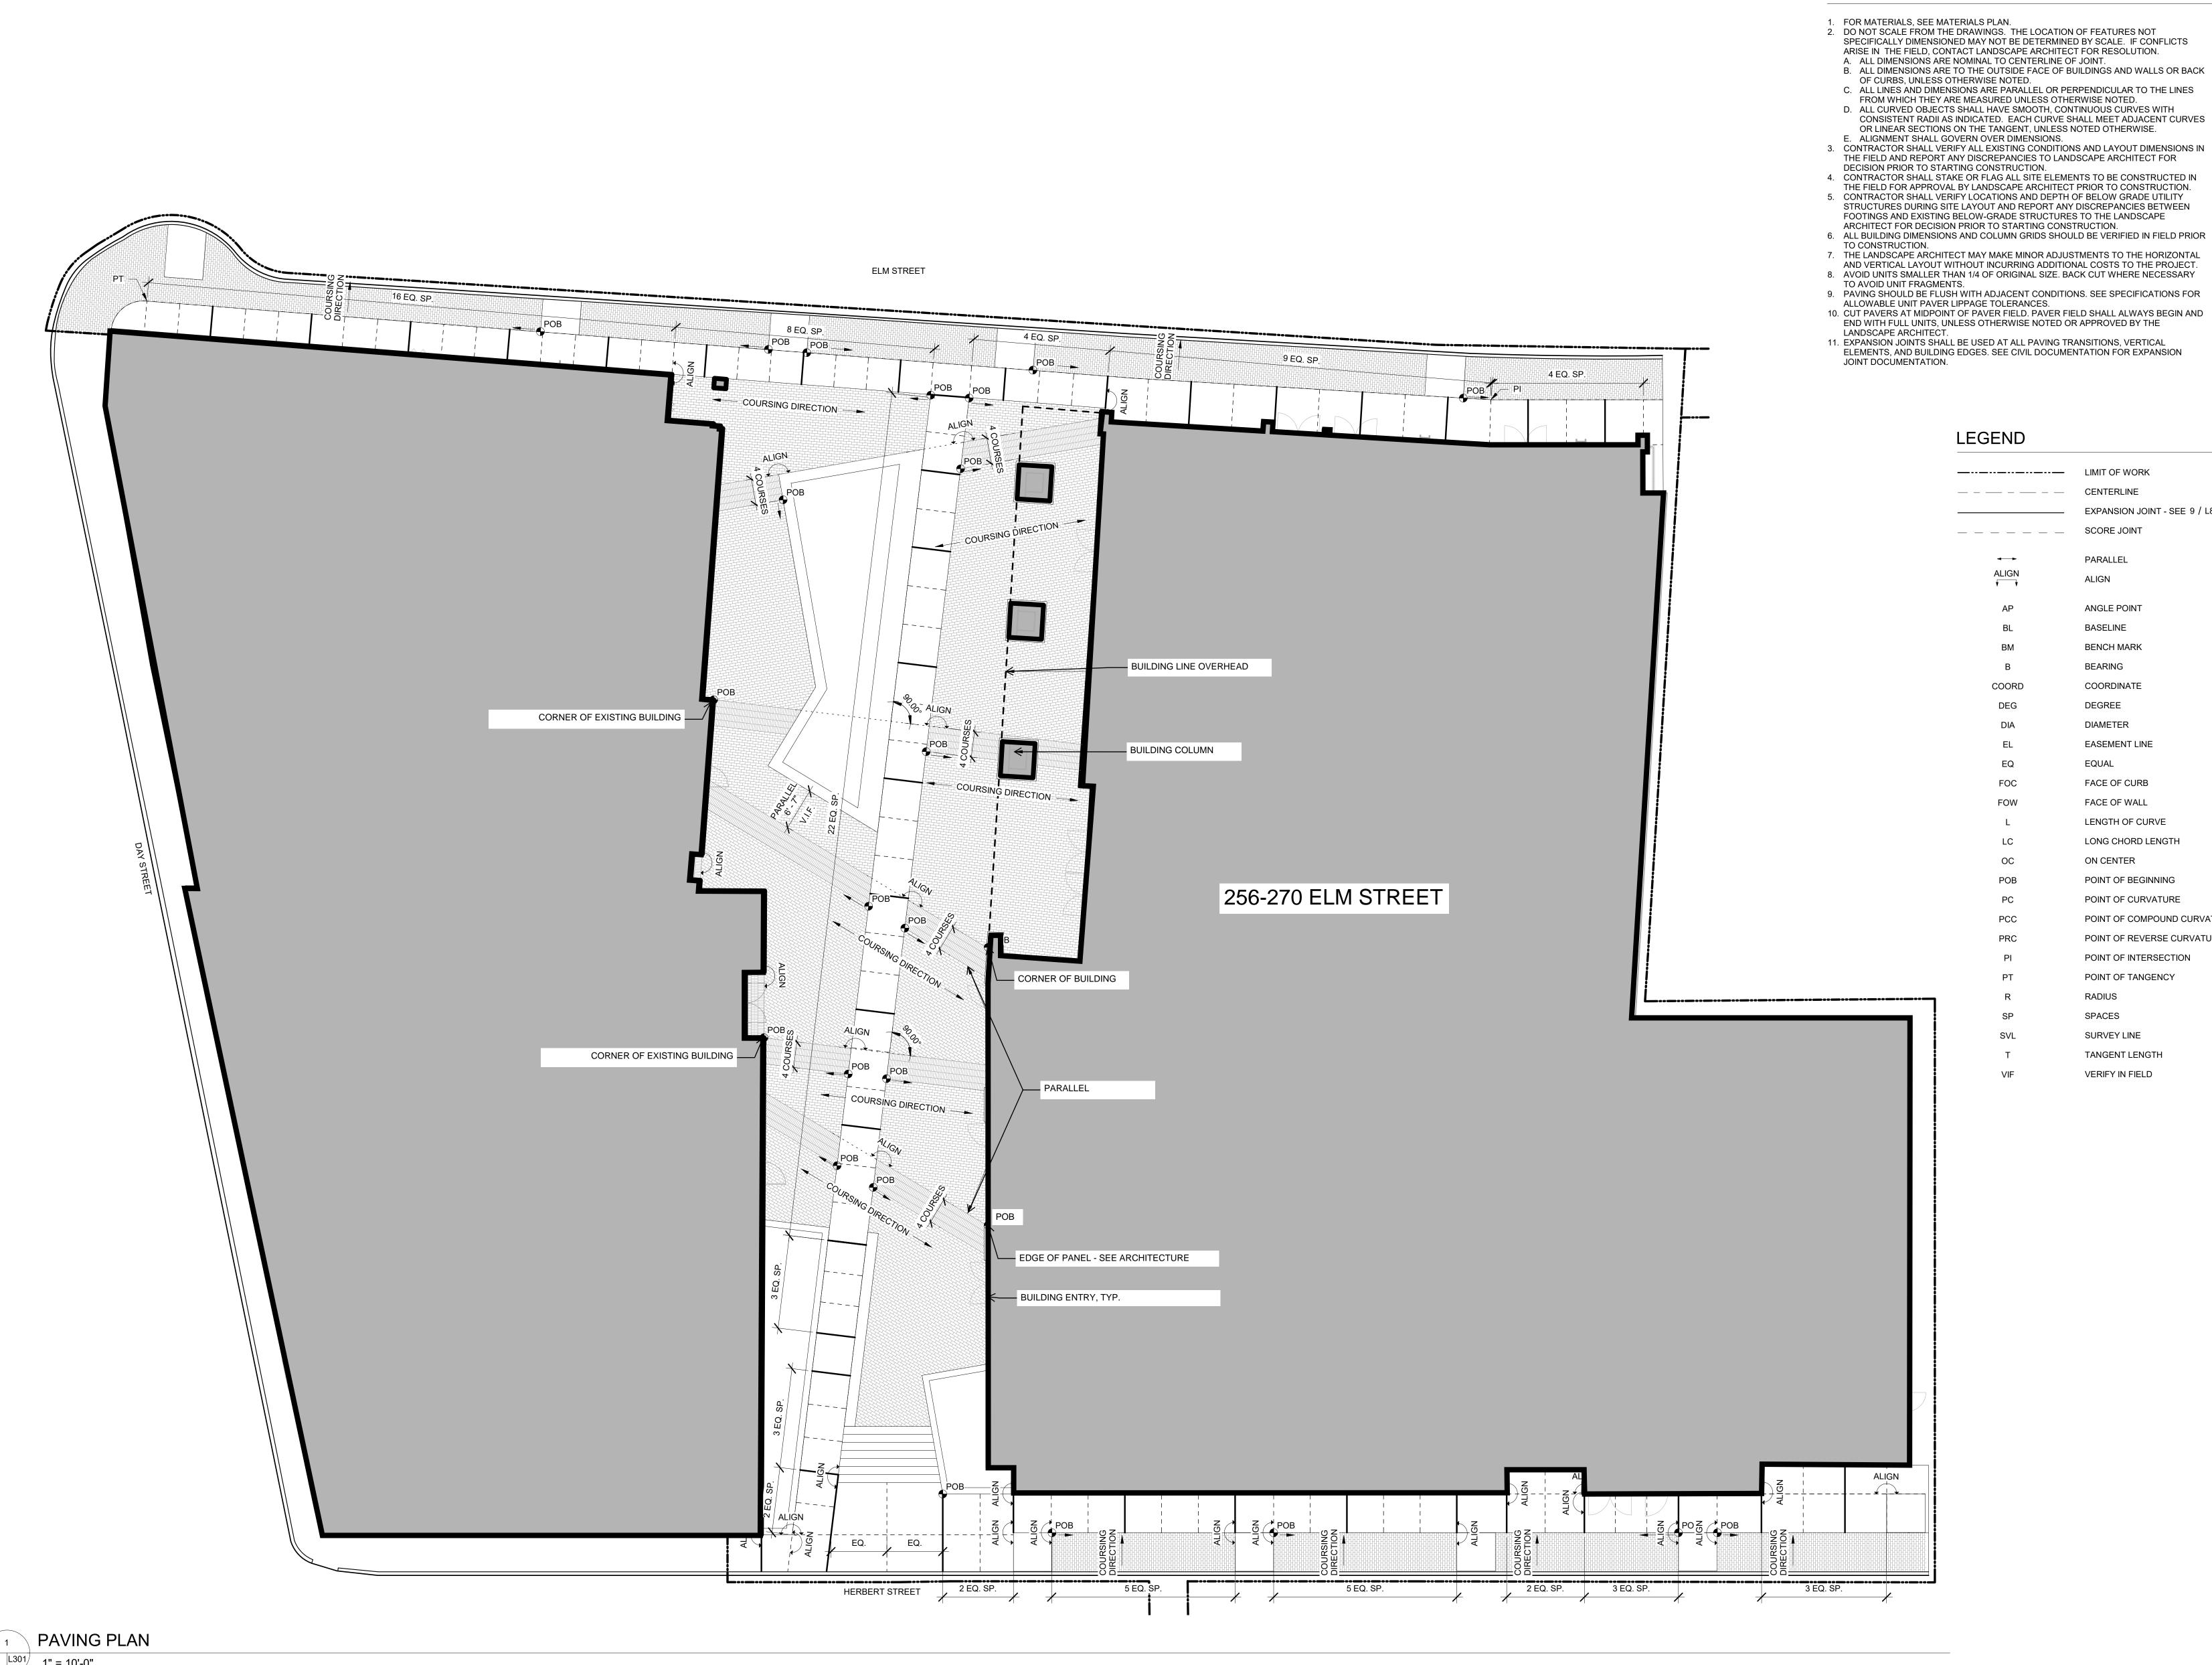

PAVING PLAN NOTES

2. DO NOT SCALE FROM THE DRAWINGS. THE LOCATION OF FEATURES NOT SPECIFICALLY DIMENSIONED MAY NOT BE DETERMINED BY SCALE. IF CONFLICTS ARISE IN THE FIELD, CONTACT LANDSCAPE ARCHITECT FOR RESOLUTION. A. ALL DIMENSIONS ARE NOMINAL TO CENTERLINE OF JOINT.

C. ALL LINES AND DIMENSIONS ARE PARALLEL OR PERPENDICULAR TO THE LINES FROM WHICH THEY ARE MEASURED UNLESS OTHERWISE NOTED. D. ALL CURVED OBJECTS SHALL HAVE SMOOTH, CONTINUOUS CURVES WITH CONSISTENT RADII AS INDICATED. EACH CURVE SHALL MEET ADJACENT CURVES OR LINEAR SECTIONS ON THE TANGENT, UNLESS NOTED OTHERWISE.

3. CONTRACTOR SHALL VERIFY ALL EXISTING CONDITIONS AND LAYOUT DIMENSIONS IN THE FIELD AND REPORT ANY DISCREPANCIES TO LANDSCAPE ARCHITECT FOR

4. CONTRACTOR SHALL STAKE OR FLAG ALL SITE ELEMENTS TO BE CONSTRUCTED IN THE FIELD FOR APPROVAL BY LANDSCAPE ARCHITECT PRIOR TO CONSTRUCTION. 5. CONTRACTOR SHALL VERIFY LOCATIONS AND DEPTH OF BELOW GRADE UTILITY STRUCTURES DURING SITE LAYOUT AND REPORT ANY DISCREPANCIES BETWEEN FOOTINGS AND EXISTING BELOW-GRADE STRUCTURES TO THE LANDSCAPE

6. ALL BUILDING DIMENSIONS AND COLUMN GRIDS SHOULD BE VERIFIED IN FIELD PRIOR 7. THE LANDSCAPE ARCHITECT MAY MAKE MINOR ADJUSTMENTS TO THE HORIZONTAL

AND VERTICAL LAYOUT WITHOUT INCURRING ADDITIONAL COSTS TO THE PROJECT. 8. AVOID UNITS SMALLER THAN 1/4 OF ORIGINAL SIZE. BACK CUT WHERE NECESSARY

9. PAVING SHOULD BE FLUSH WITH ADJACENT CONDITIONS. SEE SPECIFICATIONS FOR ALLOWABLE UNIT PAVER LIPPAGE TOLERANCES.

11. EXPANSION JOINTS SHALL BE USED AT ALL PAVING TRANSITIONS, VERTICAL

ELEMENTS, AND BUILDING EDGES. SEE CIVIL DOCUMENTATION FOR EXPANSION

LEGEND	
	LIMIT OF WORK
	CENTERLINE
	EXPANSION JOINT - SEE 9 / L80
	SCORE JOINT
←→	PARALLEL
ALIGN	ALIGN
AP	ANGLE POINT
BL	BASELINE
ВМ	BENCH MARK
В	BEARING
COORD	COORDINATE
DEG	DEGREE
DIA	DIAMETER
EL	EASEMENT LINE
EQ	EQUAL
FOC	FACE OF CURB
FOW	FACE OF WALL
L	LENGTH OF CURVE
LC	LONG CHORD LENGTH
OC	ON CENTER
POB	POINT OF BEGINNING
PC	POINT OF CURVATURE
PCC	POINT OF COMPOUND CURVATU
PRC	POINT OF REVERSE CURVATURI
PI	POINT OF INTERSECTION
PT	POINT OF TANGENCY
R	RADIUS
SP	SPACES
SVL	SURVEY LINE
Т	TANGENT LENGTH
VIF	VERIFY IN FIELD

Perkins&Will

225 Franklin Street, Suite 1100 Boston, MA 02110 t 617.478.0300 f 617.478.0321 www.perkinswill.com

> Jensen Hughes One Lincoln Street Boston, MA 02111 t 1-508-273-8481

Bohler Engineers 45 Franklin Street Boston, MA 02110 t 617-478-0300

LANDSCAPE CONSULTANT MCLV 524 Walnut St. #330 Kansas City, MO 64106 t816-945-4119

sustainability consultant The Green Engineer 23 Bradford Street Concord, MA 01742

t 978-341-5462

t 617-494-1464

t 617-494-1464

RFS Engineering 50 Milk Street Boston, MA 02109

RFS Engineering 50 Milk Street Boston, MA 02109

PROJECT




Davis Square Plaza




ASANA PARTNERS

1616 Camden Road Suite 210 Charlotte, NC 28203

KEYPLAN

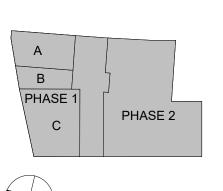


ISSUE CHART

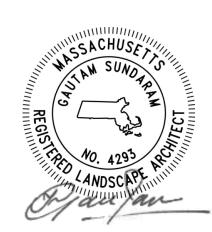

TITLE

SITE PAVING PLAN

SHEET NUMBER

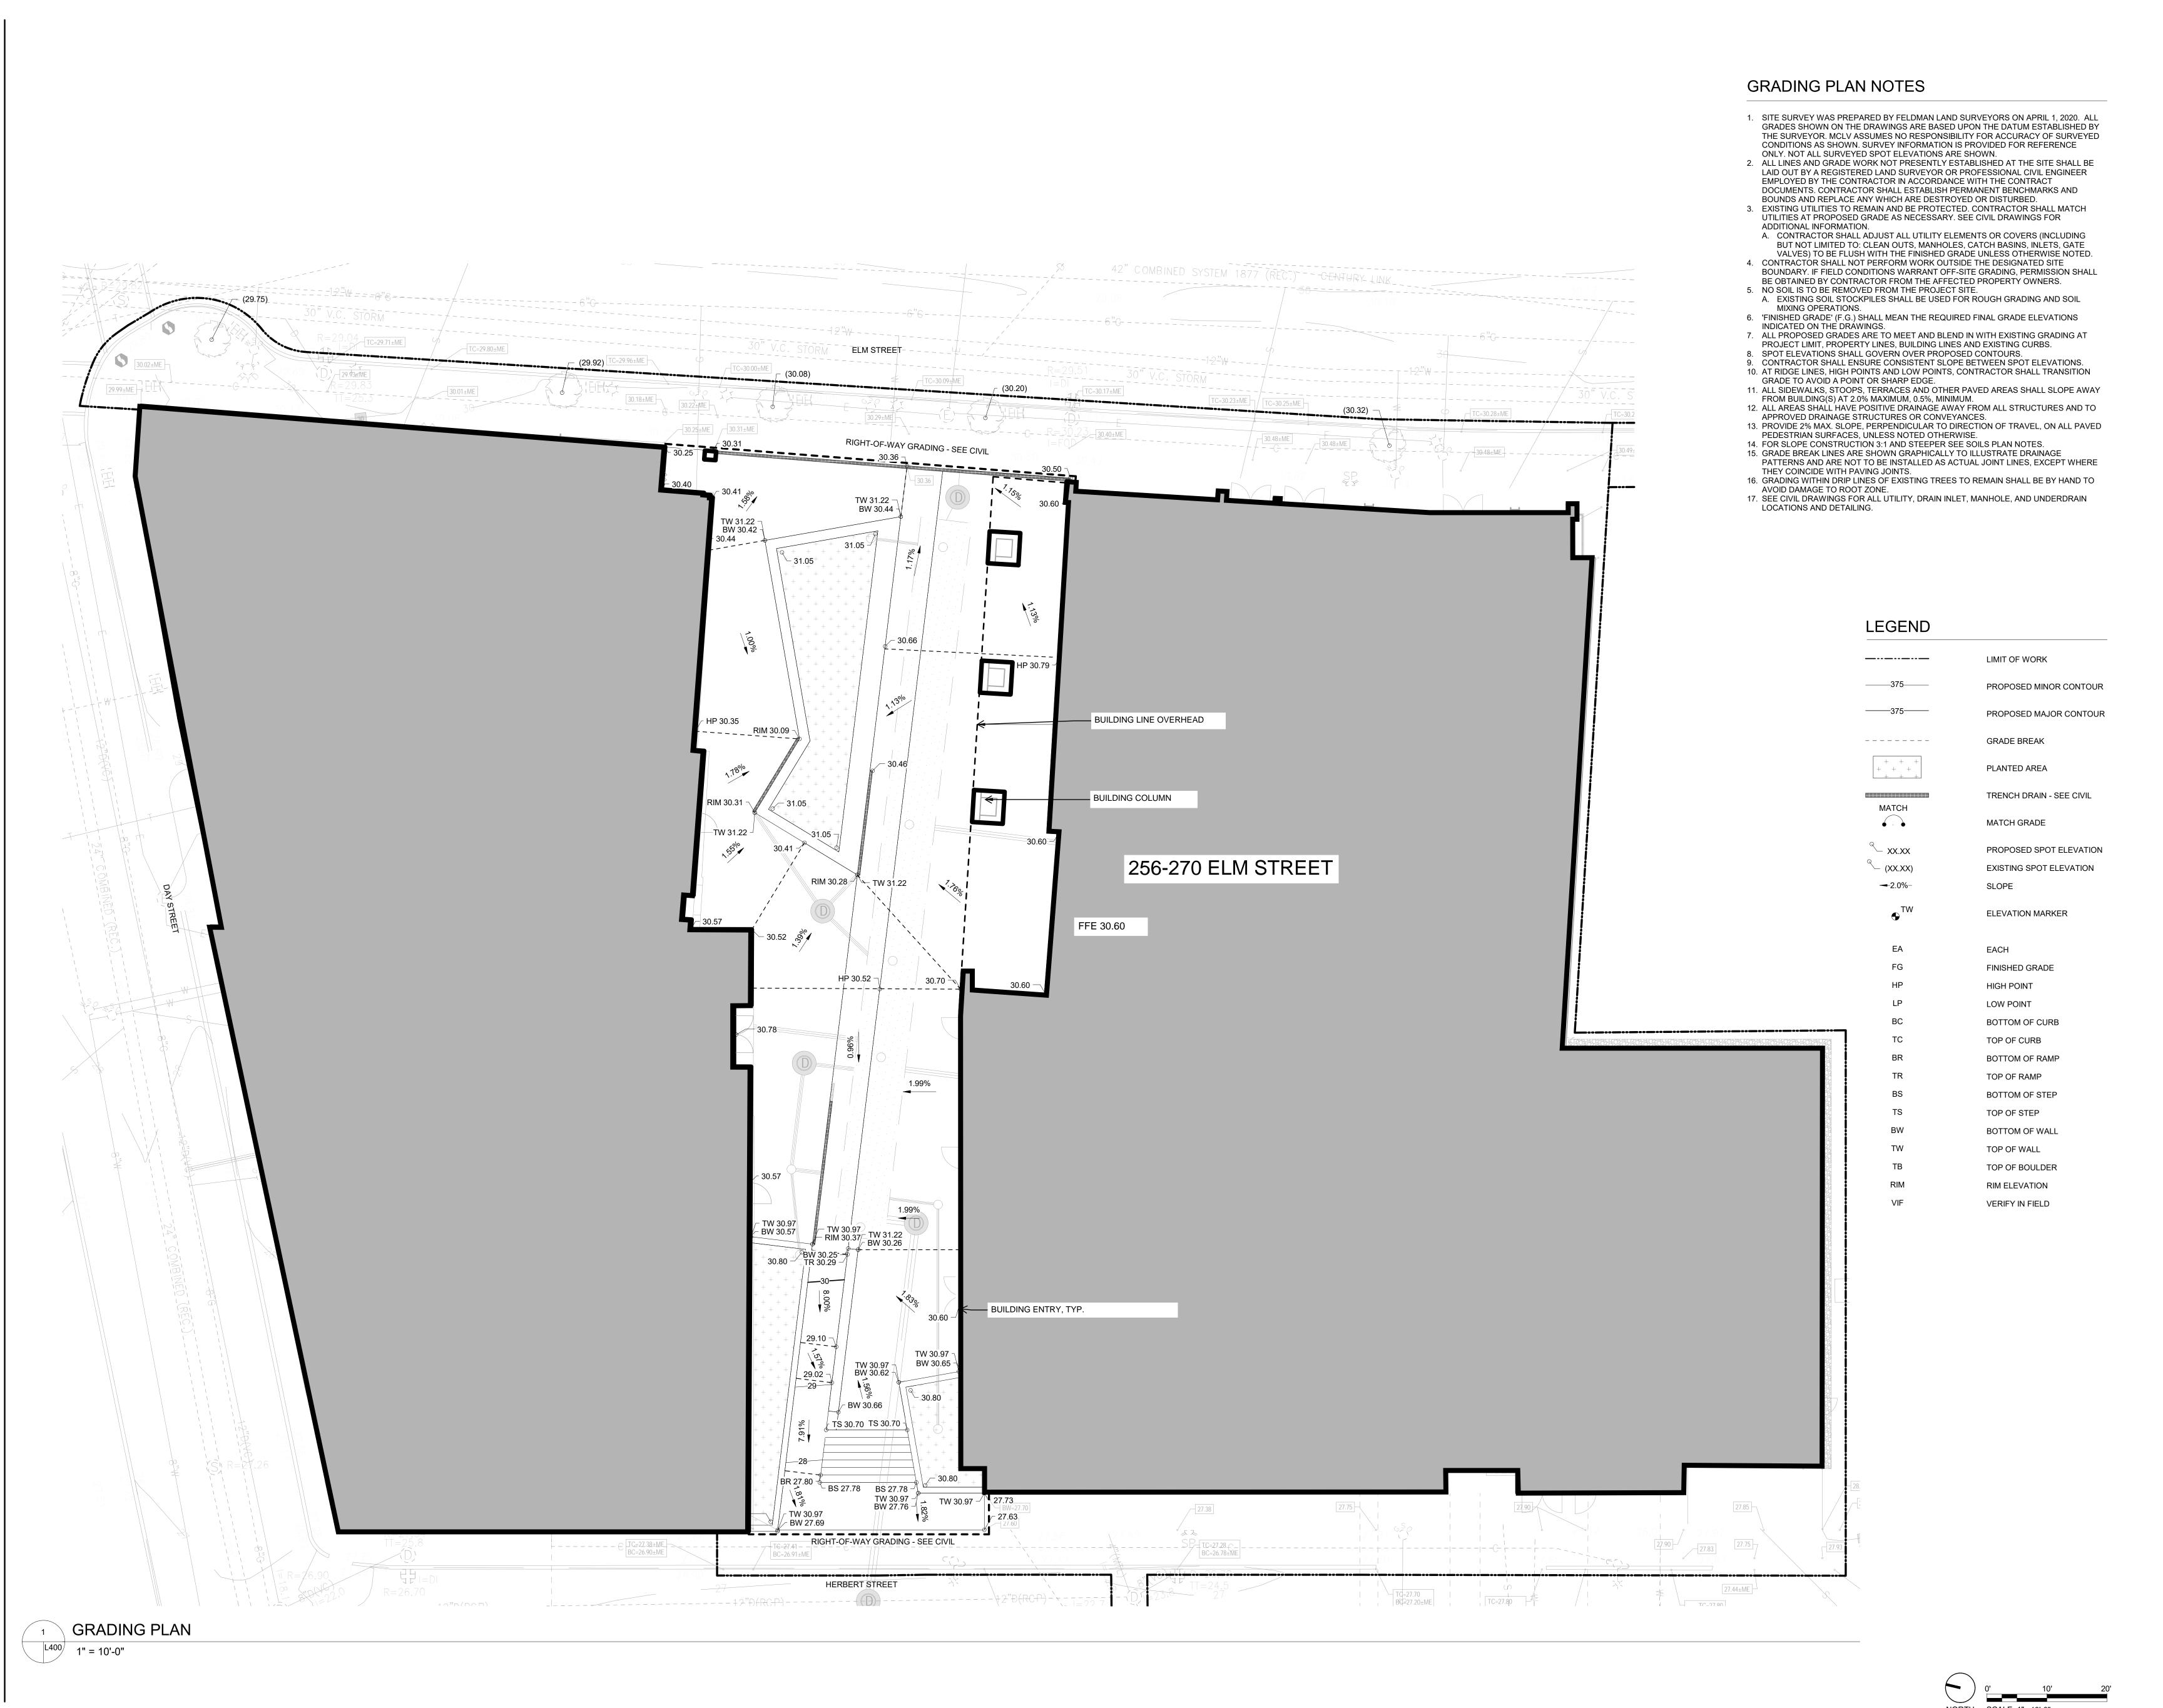

225 Franklin Street, Suite 1100 Boston, MA 02110 t 617.478.0300 f 617.478.0321 www.perkinswill.com

Jensen Hughes
One Lincoln Street
Boston, MA 02111

t 1-508-273-8481

Bohler Engineers
45 Franklin Street
Boston, MA 02110
t 617-478-0300

LANDSCAPE CONSULTANT MCLV 524 Walnut St. #330 Kansas City, MO 64106 t816-945-4119

SUSTAINABILITY CONSULTANT
The Green Engineer

23 Bradford Street
Concord, MA 01742

t 978-341-5462

t 617-494-1464

t 617-494-1464

STRUCTURAL RFS Engineering 50 Milk Street Boston, MA 02109

RFS Engineering 50 Milk Street Boston, MA 02109

PROJECT



Davis Square Plaza




ASANA PARTNERS


1616 Camden Road Suite 210

Charlotte, NC 28203

KEYPLAN

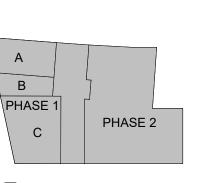

ISSUE CHART

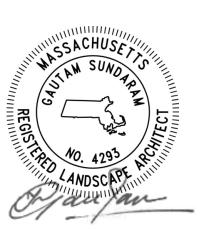

Job Number 2206

SITE GRADING PLAN

SHEET NUMBER

ARISE IN THE FIELD, CONTACT LANDSCAPE ARCHITECT FOR RESOLUTION. A. ALL DIMENSIONS ARE TO THE OUTSIDE FACE OF BUILDINGS AND WALLS OR BACK OF CURBS, UNLESS OTHERWISE NOTED. DRAWINGS AND FABRICATIONS. DO NOT DELAY JOB PROGRESS. LEGEND **ELM STREET** BUILDING LINE OVERHEAD BUILDING COLUMN 256-270 ELM STREET BUILDING ENTRY, TYP. HERBERT STREET FURNISHINGS PLAN L500 1" = 10'-0"

FURNISHINGS PLAN NOTES

- 1. SITE FURNISHING LAYOUTS TO BE STAKED IN FIELD AND VERIFIED BY LANDSCAPE
- ARCHITECT PRIOR TO INSTALLATION. 2. CONTRACTOR SHALL VERIFY DIMENSIONS SHOWN AND NOTIFY THE LANDSCAPE ARCHITECT OF ANY DISCREPANCIES PRIOR TO CONSTRUCTION. 3. DO NOT SCALE FROM THE DRAWINGS. THE LOCATION OF FEATURES NOT SPECIFICALLY DIMENSIONED MAY NOT BE DETERMINED BY SCALE. IF CONFLICTS
- B. ALL LINES AND DIMENSIONS ARE PARALLEL OR PERPENDICULAR TO THE LINES FROM WHICH THEY ARE MEASURED UNLESS OTHERWISE NOTED. 4. CONTRACTOR TO PROVIDE FIELD MEASUREMENTS BEFORE PREPARATION OF SHOP
- 5. PRIOR TO FINAL LAYOUT AND PLACEMENT OF ELEMENTS, THE CONTRACTOR SHALL VERIFY PROPOSED OVERALL DIMENSIONS AND ELEVATIONS OF SITE IMPROVEMENTS IN RELATION TO WHAT IS SHOWN ON THE DRAWINGS. THE CONTRACTOR SHALL REPORT ANY DISCREPANCIES IN WRITING TO THE LANDSCAPE ARCHITECT.

————— LIMIT OF WORK HANDRAIL - SEE 4 / L820 TREE GUARD - SEE 4 / L830 SEAT WALL - SEE L811 LITTER RECEPTACLE TYPE 1 - SEE 2 / L830 LITTER RECEPTACLE TYPE 2 - SEE 3 / L830 TABLE AND CHAIRS - SEE SPECS -QUANTITIES TO BE VERIFIED AND APPROVED BY OWNER BICYCLE RACKS - SEE 1 / L830

PROJECT



Davis Square Plaza

Perkins&Will

225 Franklin Street, Suite 1100

Boston, MA 02110

www.perkinswill.com

Jensen Hughes

One Lincoln Street Boston, MA 02111

t 1-508-273-8481

Bohler Engineers

45 Franklin Street

Boston, MA 02110 t 617-478-0300

LANDSCAPE ARCHITECT PERKINS&WILL

Boston, MA 02110 t 617.478.0300 f 617.478.0321

LANDSCAPE CONSULTANT

524 Walnut St. #330 Kansas City, MO 64106 t816-945-4119

SUSTAINABILITY CONSULTANT

23 Bradford Street

STRUCTURAL

50 Milk Street

t 617-494-1464

Boston, MA 02109

RFS Engineering 50 Milk Street Boston, MA 02109 t 617-494-1464

Concord, MA 01742 t 978-341-5462

RFS Engineering

The Green Engineer

MCLV

225 Franklin Street, Suite 1100

t 617.478.0300

f 617.478.0321




ASANA PARTNERS

1616 Camden Road Suite 210

Charlotte, NC 28203

KEYPLAN

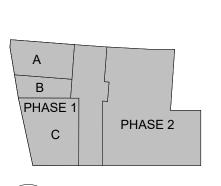

ISSUE CHART



SITE FURNISHINGS

SHEET NUMBER

LEGEND LIMIT OF WORK ELM STREET BUILDING LINE OVERHEAD SEE L810 FOR LAYOUT BUILDING COLUMN 256-270 ELM STREET SEE L810 FOR LAYOU BUILDING ENTRY, TYP. — SEE L810 FOR LAYOUT, TYP. HERBERT STREET SITE LIGHTING AND OUTLET PLAN L501 1" = 10'-0"

LIGHTING AND OUTLET PLAN NOTES

1. SEE MEP PLANS AND SPECIFICATIONS FOR LIGHT FIXTURE DOCUMENTATION. 2. SEE ARCHITECTURE AND MEP DOCUMENTATION FOR OVERHEAD CATENARY LIGHT FIXTURE LAYOUT.

> LA2 - WALL ACCENT LIGHT 5 / L830 LA3 - LINEAR LIGHT 7 / L811 LA4 - WALL LIGHT 1 / L811 LA5 - TREE ACCENT LIGHT 7 / L830 RECEPTACLE BOLLARD - VERIFY LOCATIONS IN FIELD - SEE 6 / L830

Perkins&Will

225 Franklin Street, Suite 1100 Boston, MA 02110 t 617.478.0300 f 617.478.0321 www.perkinswill.com

> Jensen Hughes One Lincoln Street Boston, MA 02111 t 1-508-273-8481

Bohler Engineers 45 Franklin Street Boston, MA 02110 t 617-478-0300

LANDSCAPE ARCHITECT PERKINS&WILL 225 Franklin Street, Suite 1100 Boston, MA 02110 t 617.478.0300 f 617.478.0321

> LANDSCAPE CONSULTANT MCLV 524 Walnut St. #330 Kansas City, MO 64106 t816-945-4119

sustainability consultant The Green Engineer 23 Bradford Street Concord, MA 01742

> STRUCTURAL RFS Engineering 50 Milk Street Boston, MA 02109 t 617-494-1464

t 978-341-5462

RFS Engineering 50 Milk Street Boston, MA 02109 t 617-494-1464

PROJECT



Davis Square Plaza




A S A N A PARTNERS **ASANA PARTNERS**

1616 Camden Road Suite 210

Charlotte, NC 28203

KEYPLAN

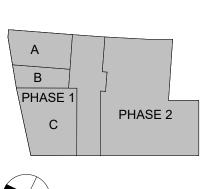


ISSUE CHART



TITLE

SITE LIGHTING AND **OUTLET PLAN**

SHEET NUMBER

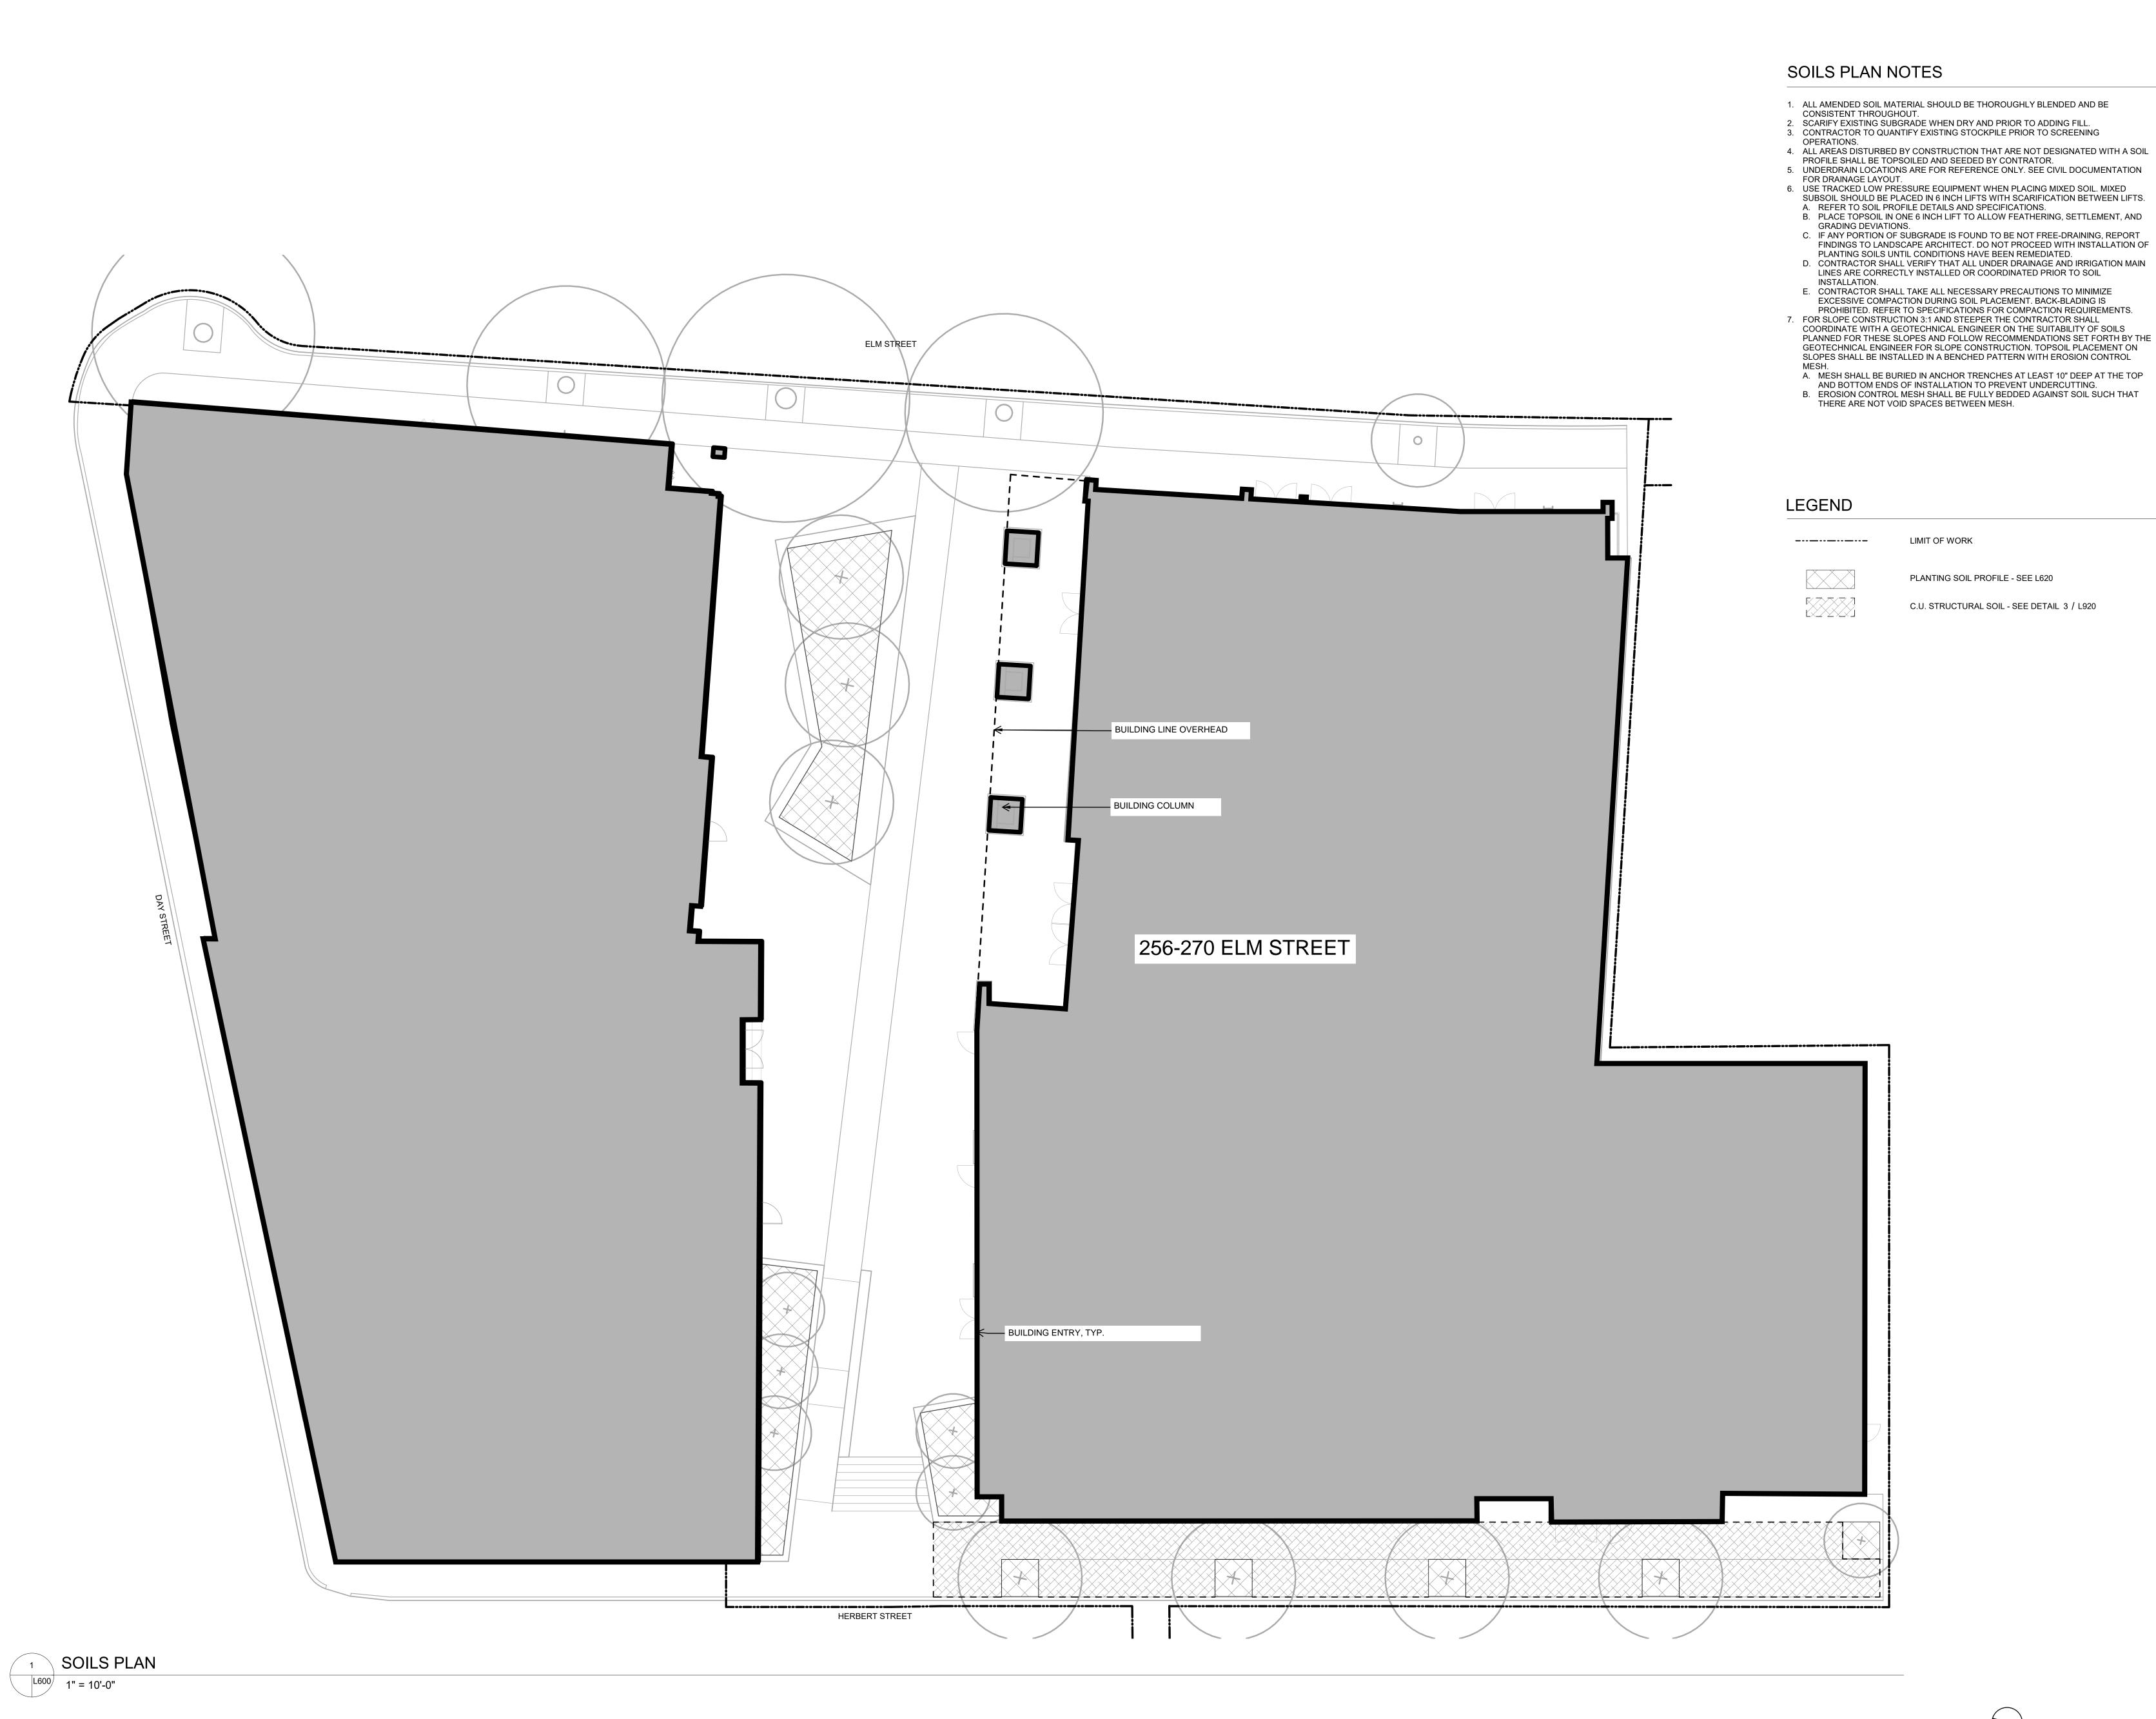

- 1. ALL AMENDED SOIL MATERIAL SHOULD BE THOROUGHLY BLENDED AND BE
- 4. ALL AREAS DISTURBED BY CONSTRUCTION THAT ARE NOT DESIGNATED WITH A SOIL
- 6. USE TRACKED LOW PRESSURE EQUIPMENT WHEN PLACING MIXED SOIL. MIXED SUBSOIL SHOULD BE PLACED IN 6 INCH LIFTS WITH SCARIFICATION BETWEEN LIFTS.
- B. PLACE TOPSOIL IN ONE 6 INCH LIFT TO ALLOW FEATHERING, SETTLEMENT, AND C. IF ANY PORTION OF SUBGRADE IS FOUND TO BE NOT FREE-DRAINING, REPORT
- PLANTING SOILS UNTIL CONDITIONS HAVE BEEN REMEDIATED. D. CONTRACTOR SHALL VERIFY THAT ALL UNDER DRAINAGE AND IRRIGATION MAIN
- LINES ARE CORRECTLY INSTALLED OR COORDINATED PRIOR TO SOIL
- PROHIBITED. REFER TO SPECIFICATIONS FOR COMPACTION REQUIREMENTS. 7. FOR SLOPE CONSTRUCTION 3:1 AND STEEPER THE CONTRACTOR SHALL COORDINATE WITH A GEOTECHNICAL ENGINEER ON THE SUITABILITY OF SOILS
- PLANNED FOR THESE SLOPES AND FOLLOW RECOMMENDATIONS SET FORTH BY THE GEOTECHNICAL ENGINEER FOR SLOPE CONSTRUCTION. TOPSOIL PLACEMENT ON SLOPES SHALL BE INSTALLED IN A BENCHED PATTERN WITH EROSION CONTROL
- A. MESH SHALL BE BURIED IN ANCHOR TRENCHES AT LEAST 10" DEEP AT THE TOP AND BOTTOM ENDS OF INSTALLATION TO PREVENT UNDERCUTTING.
- B. EROSION CONTROL MESH SHALL BE FULLY BEDDED AGAINST SOIL SUCH THAT

PLANTING SOIL PROFILE - SEE L620

C.U. STRUCTURAL SOIL - SEE DETAIL 3 / L920

PROJECT



Davis Square Plaza

Perkins&Will

225 Franklin Street, Suite 1100

Boston, MA 02110

www.perkinswill.com

Jensen Hughes

One Lincoln Street

Boston, MA 02111 t 1-508-273-8481

Bohler Engineers

45 Franklin Street

Boston, MA 02110

LANDSCAPE ARCHITECT

Boston, MA 02110

LANDSCAPE CONSULTANT

524 Walnut St. #330

t816-945-4119

Kansas City, MO 64106

SUSTAINABILITY CONSULTANT

23 Bradford Street Concord, MA 01742 t 978-341-5462

RFS Engineering

RFS Engineering

STRUCTURAL

50 Milk Street Boston, MA 02109

t 617-494-1464

50 Milk Street Boston, MA 02109

t 617-494-1464

The Green Engineer

t 617.478.0300

f 617.478.0321

MCLV

225 Franklin Street, Suite 1100

PERKINS&WILL

t 617-478-0300

t 617.478.0300

f 617.478.0321

A S A N A PARTNERS **ASANA PARTNERS**

1616 Camden Road Suite 210

Charlotte, NC 28203


KEYPLAN


ISSUE CHART





SITE SOILS PLAN

SHEET NUMBER

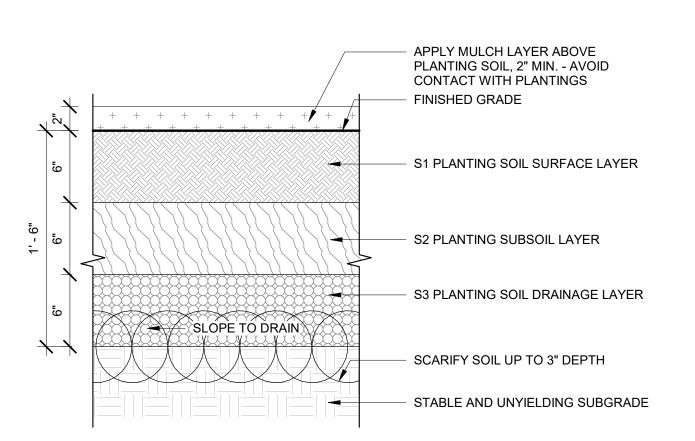

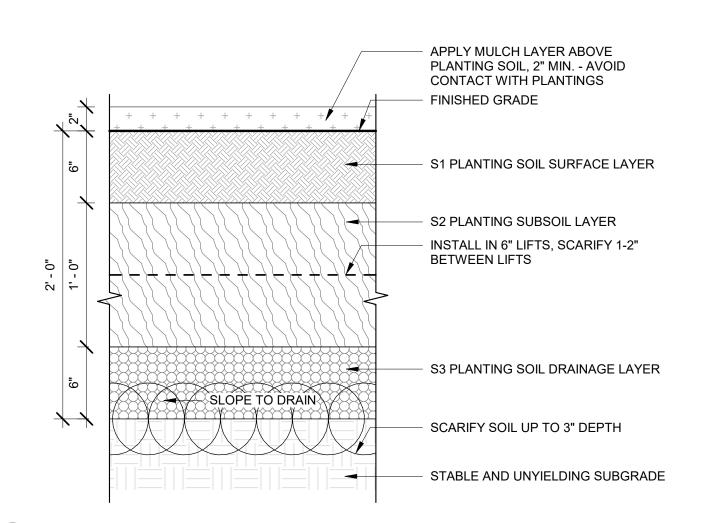

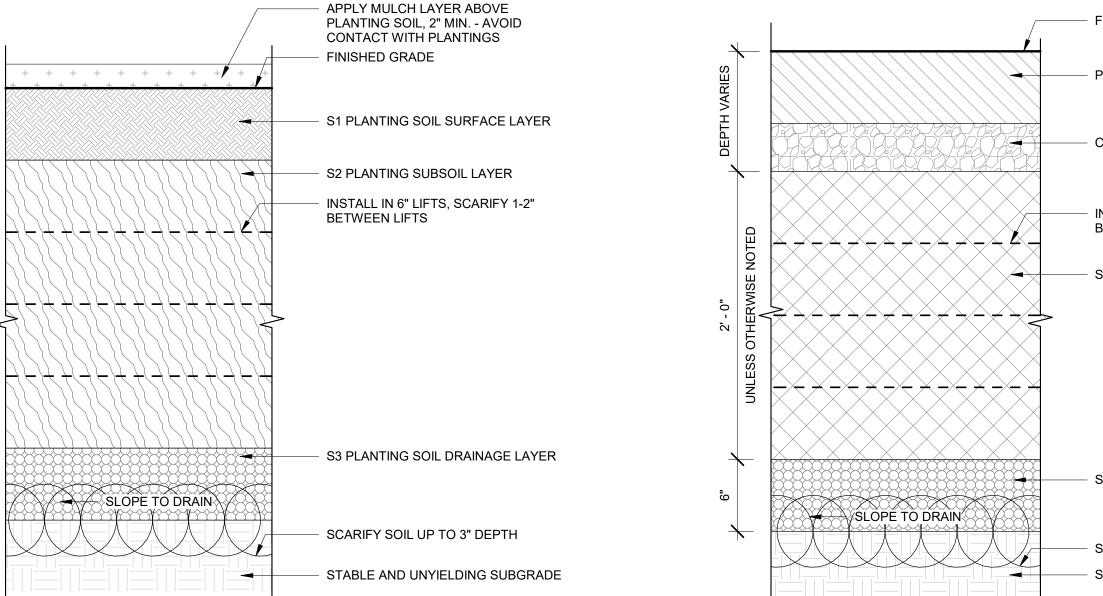


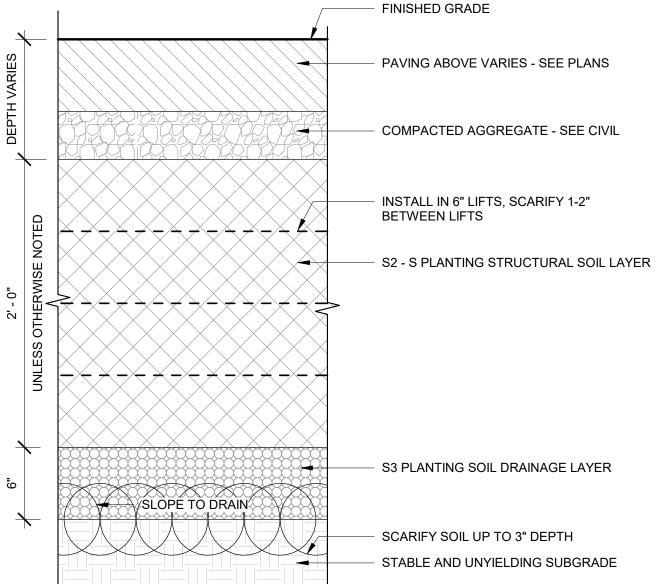


4 PLANTING SOIL PROFILE - STRUCTURAL 1 1/2" = 1'-0"





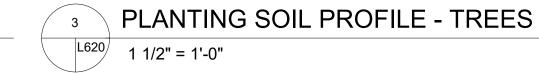

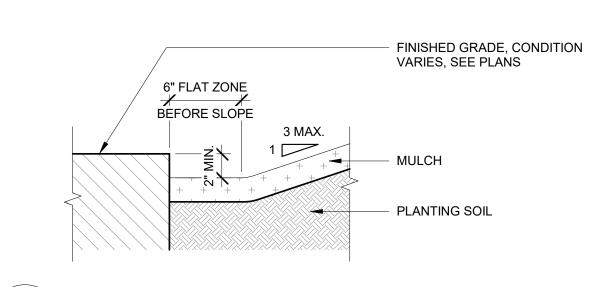

PLANTING SOIL AT SURFACE

PROJECT



Perkins&Will

225 Franklin Street, Suite 1100

Boston, MA 02110

www.perkinswill.com

Jensen Hughes

One Lincoln Street

Boston, MA 02111

t 1-508-273-8481

Bohler Engineers

45 Franklin Street

Boston, MA 02110 t 617-478-0300

LANDSCAPE ARCHITECT PERKINS&WILL

Boston, MA 02110

LANDSCAPE CONSULTANT

524 Walnut St. #330 Kansas City, MO 64106 t816-945-4119

sustainability consultant The Green Engineer

23 Bradford Street Concord, MA 01742 t 978-341-5462

RFS Engineering

RFS Engineering

STRUCTURAL

50 Milk Street

50 Milk Street Boston, MA 02109 t 617-494-1464

Boston, MA 02109 t 617-494-1464

t 617.478.0300

f 617.478.0321

MCLV

225 Franklin Street, Suite 1100

t 617.478.0300


f 617.478.0321



ASANA PARTNERS

1616 Camden Road Suite 210 Charlotte, NC 28203

KEYPLAN

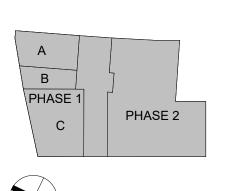


ISSUE CHART




DETAILS - SOILS

SHEET NUMBER

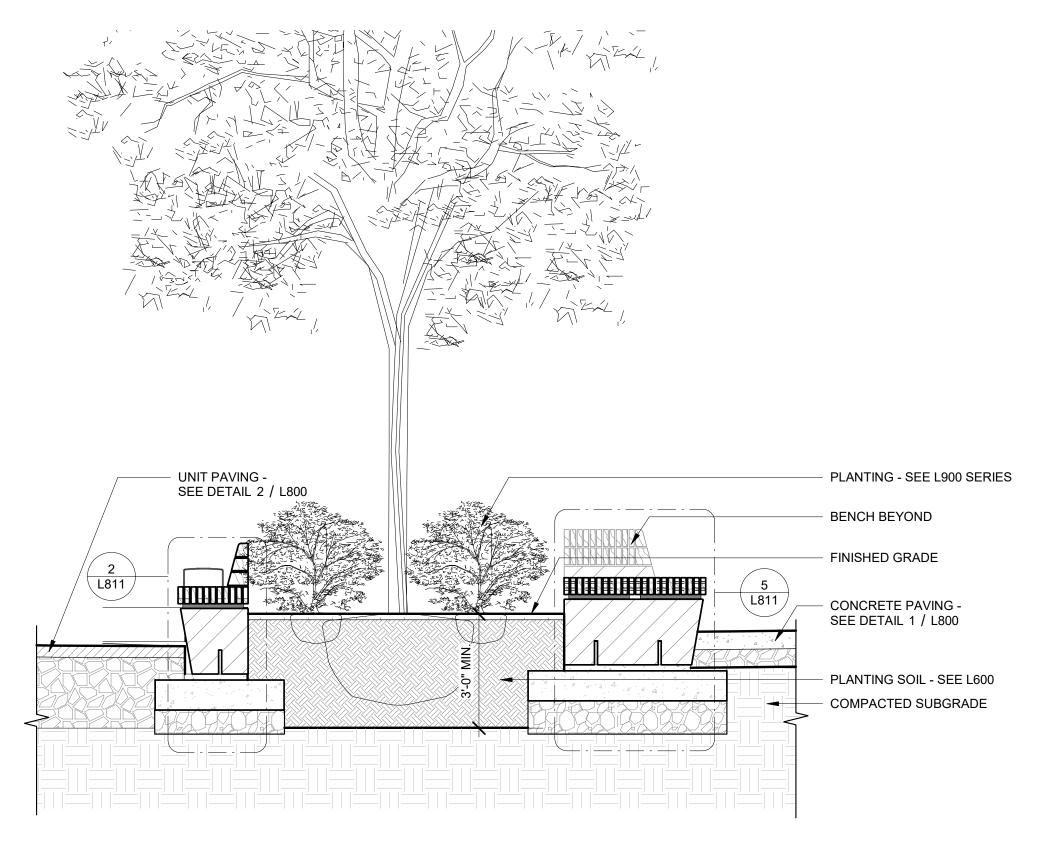


1 ILLUSTRATIVE SECTION - PLANTER A LOOKING EAST

L_{100.A}L₇₀₀ 3/8" = 1'-0"

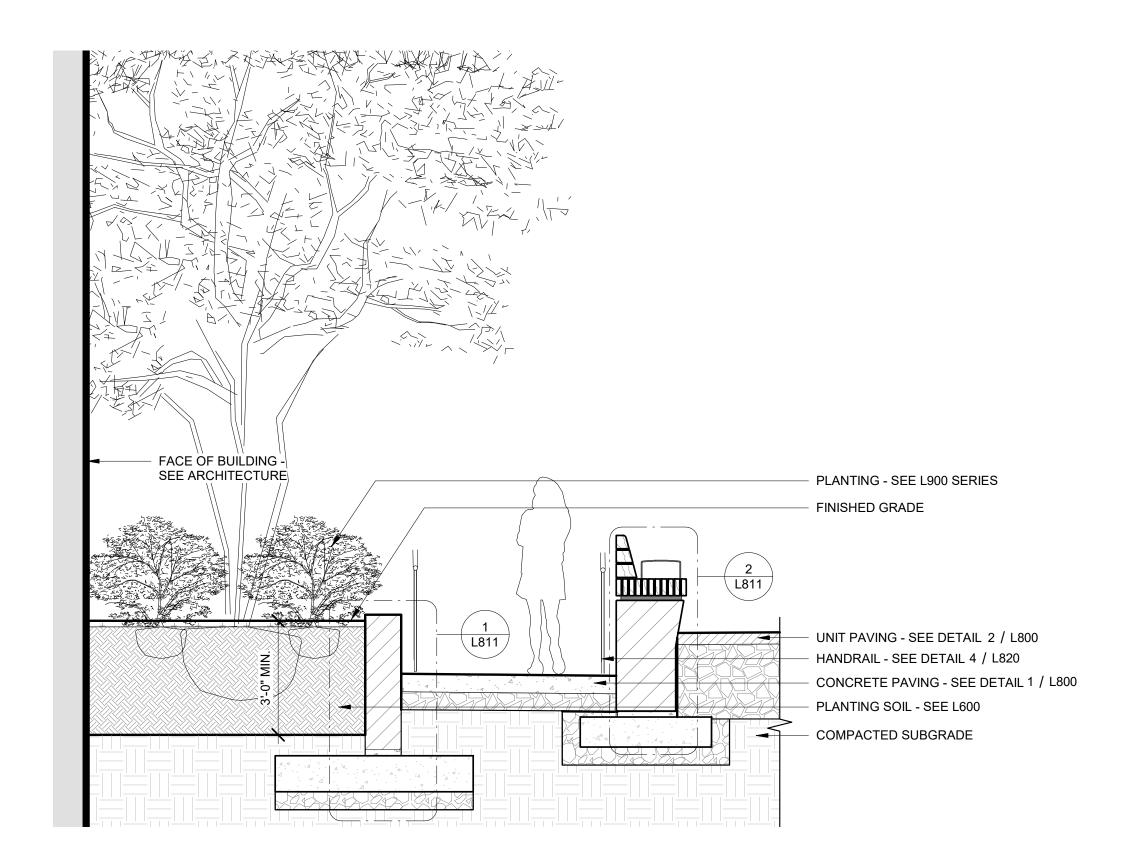

ILLUSTRATIVE SECTION - PLANTER B LOOKING EAST

00.A L700 3/8" = 1'-

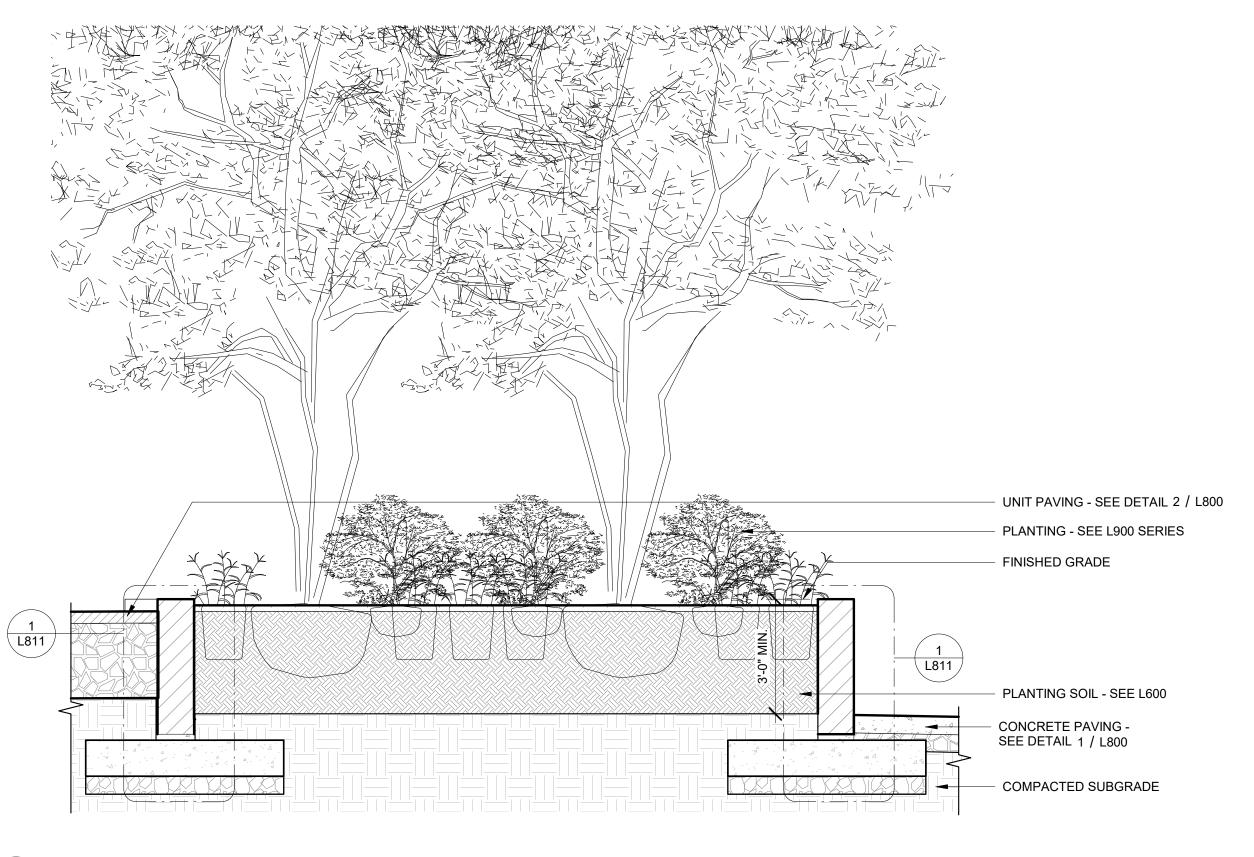

2 ILLUSTRATIVE SECTION - PLANTER C LOOKING SOUTH

3/8" = 1'-0"

Perkins&Will

225 Franklin Street, Suite 1100 Boston, MA 02110 t 617.478.0300 f 617.478.0321 www.perkinswill.com

Jensen Hughes
One Lincoln Street
Boston, MA 02111
t 1-508-273-8481

Bohler Engineers 45 Franklin Street Boston, MA 02110

LANDSCAPE CONSULTANT MCLV 524 Walnut St. #330 Kansas City, MO 64106 t816-945-4119

SUSTAINABILITY CONSULTANT
The Green Engineer
23 Bradford Street
Concord, MA 01742

t 978-341-5462

t 617-494-1464

STRUCTURAL RFS Engineering 50 Milk Street Boston, MA 02109

RFS Engineering 50 Milk Street Boston, MA 02109 t 617-494-1464

PROJECT




Davis Square Plaza



ASANA PARTNERS


1616 Camden Road Suite 210 Charlotte, NC 28203


KEYPLAN

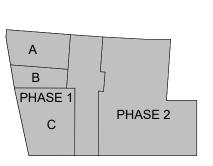



ISSUE CHART

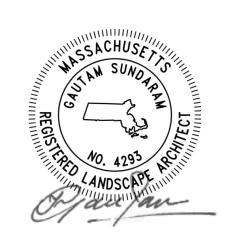

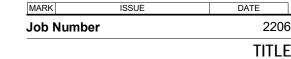


SITE SECTIONS & ELEVATIONS

SHEET NUMBER



L800 1 1/2" = 1'-0"

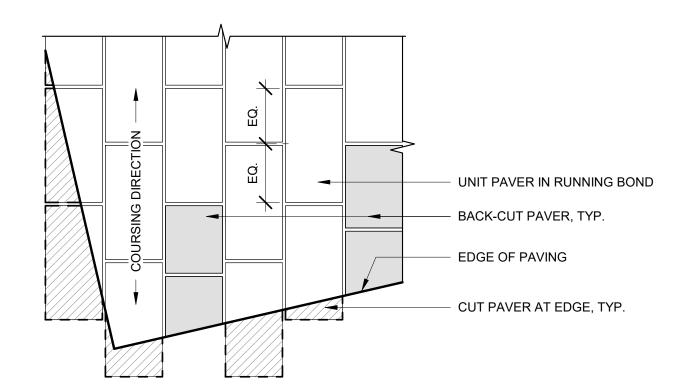


1. SEE SPECIFICATIONS FOR UNIT PAVING DIMENSIONS AND PATTERN

INFORMATION. BACK-CUT PAVERS TO AVOID UNITS SMALLER THAN 1/2 OF ORIGINAL SIZE.
 PAVERS SHALL BE FLUSH WITH ADJACENT CONDITIONS - SEE SPECIFICATION FOR ALLOWABLE UNIT PAVER LIPPAGE TOLERANCES.


UNIT PAVING PATTERN - RUNNING BOND

1 1/2" = 1'-0"

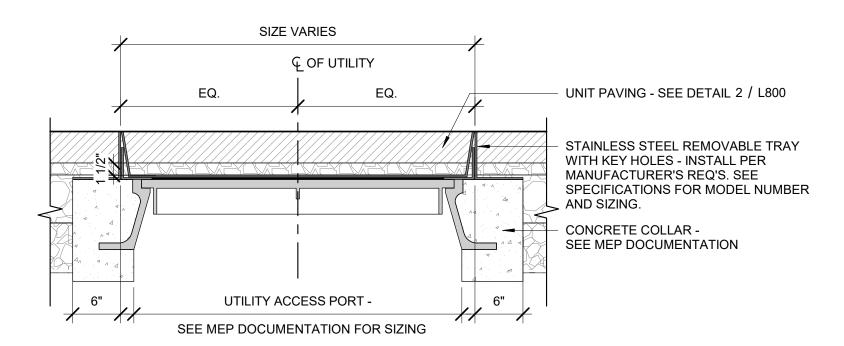


MATCH ORIENTATION PER PLANS IN ALIGNMENT WITH PAVING PATTERN.
LOCATE UTILITY COVER WITHIN FIELD OF ONE PAVING MATERIAL TYPE.

UTILITY COVER AT UNIT PAVERS

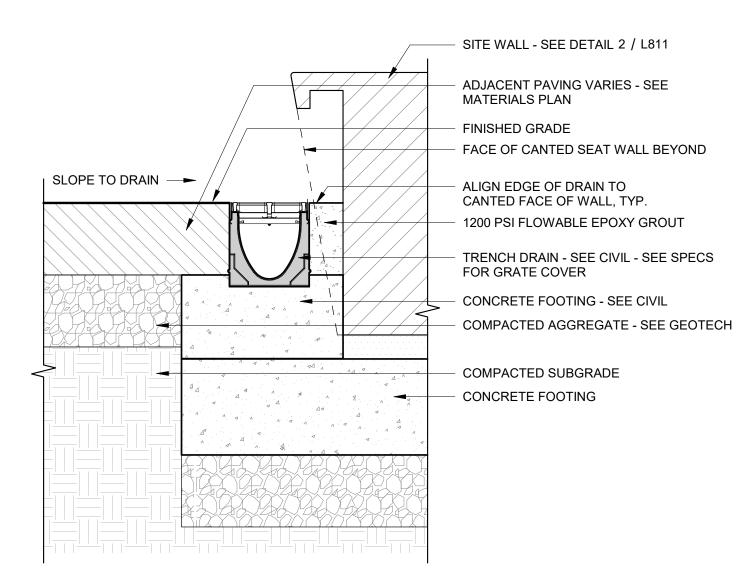


10 TRENCH DRAIN AT SEAT WALL

L200 L800 1 1/2" = 1'-0"

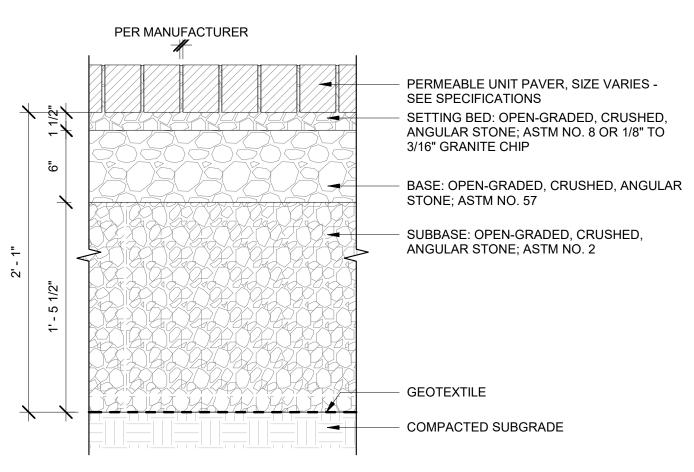

UNIT PAVERS TYPES 1 & 2 L800

1 1/2" = 1'-0"

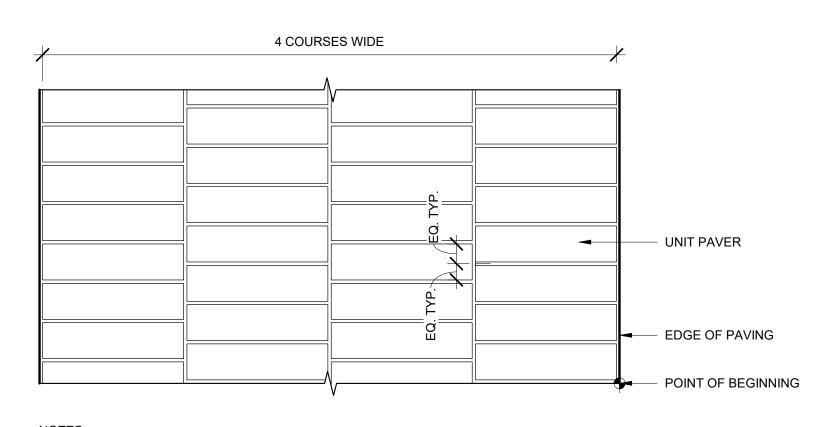


1. SEE SPECIFICATIONS FOR UNIT PAVING DIMENSIONS AND PATTERN INFORMATION.

 BACK-CUT PAVERS TO AVOID UNITS SMALLER THAN 1/2 OF ORIGINAL SIZE.
 PAVERS SHALL BE FLUSH WITH ADJACENT CONDITIONS - SEE SPECIFICATION FOR ALLOWABLE UNIT PAVER LIPPAGE TOLERANCES.

UNIT PAVING PATTERN - OFFSET STACKED BOND


L800 1 1/2" = 1'-0"

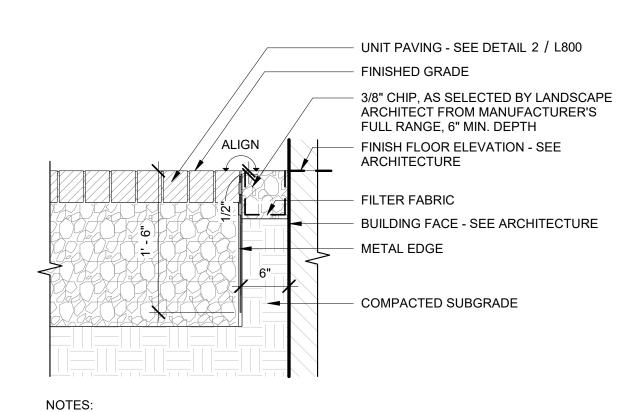

1. ENSURE NO LIPPAGE AT TRANSITION

GRAVEL EDGE AT BUILDING FACE

1" = 1'-0"

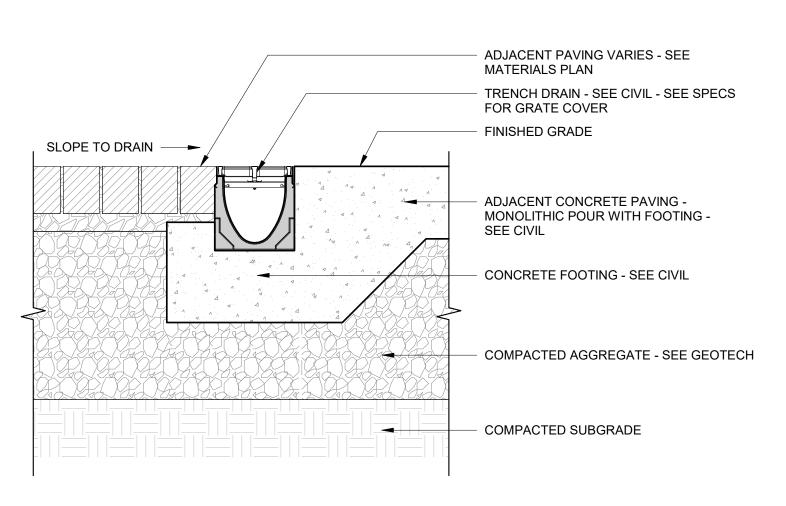


TRENCH DRAIN AT PAVING TRANSITION

L200 L800 1 1/2" = 1'-0"


PER MANUFACTURER PERMEABLE UNIT PAVER SETTING BED: OPEN-GRADED, CRUSHED, ANGULAR STONE; ASTM NO. 8 OR 1/8" TO 3/16" GRANITE CHIP BASE: OPEN-GRADED, CRUSHED, ANGULAR STONE; ASTM NO. 57 SUBBASE: OPEN-GRADED, CRUSHED, ANGULAR STONE; ASTM NO. 2 GEOTEXTILE — COMPACTED SUBGRADE

3 UNIT PAVERS TYPE 3 L800 1 1/2" = 1'-0"

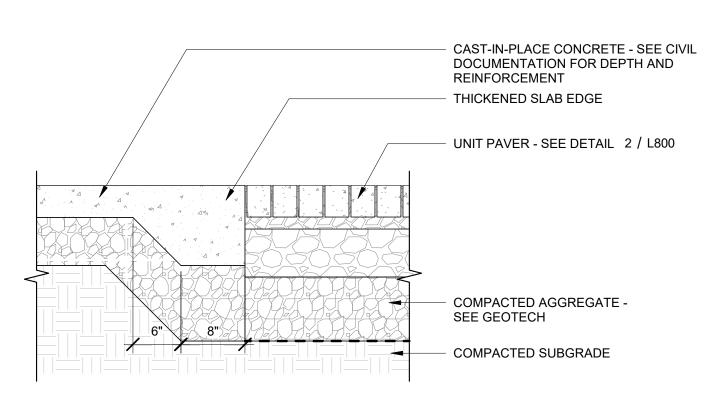

1. SEE CIVIL DOCUMENTATION FOR SPECIFICATIONS. 2. ENSURE NO LIPPAGE AT TRANSITION.

6 CAST-IN-PLACE CONCRETE AT UNIT PAVER L200 L800 1" = 1'-0"

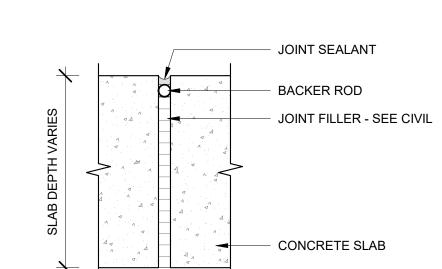

EXPANSION JOINT - TYPICAL

L800 6" = 1'-0"

Perkins&Will

225 Franklin Street, Suite 1100 Boston, MA 02110 t 617.478.0300 f 617.478.0321 www.perkinswill.com

> Jensen Hughes One Lincoln Street Boston, MA 02111 t 1-508-273-8481

Bohler Engineers 45 Franklin Street Boston, MA 02110 t 617-478-0300

LANDSCAPE CONSULTANT MCLV 524 Walnut St. #330 Kansas City, MO 64106 t816-945-4119

sustainability consultant The Green Engineer 23 Bradford Street Concord, MA 01742 t 978-341-5462

RFS Engineering 50 Milk Street Boston, MA 02109 t 617-494-1464

RFS Engineering 50 Milk Street Boston, MA 02109 t 617-494-1464

PROJECT




ASANA PARTNERS **ASANA PARTNERS**

1616 Camden Road Suite 210


Charlotte, NC 28203

KEYPLAN

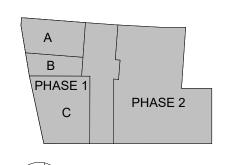


ISSUE CHART



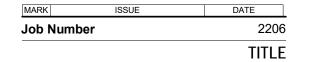

DETAILS - PAVING

SHEET NUMBER

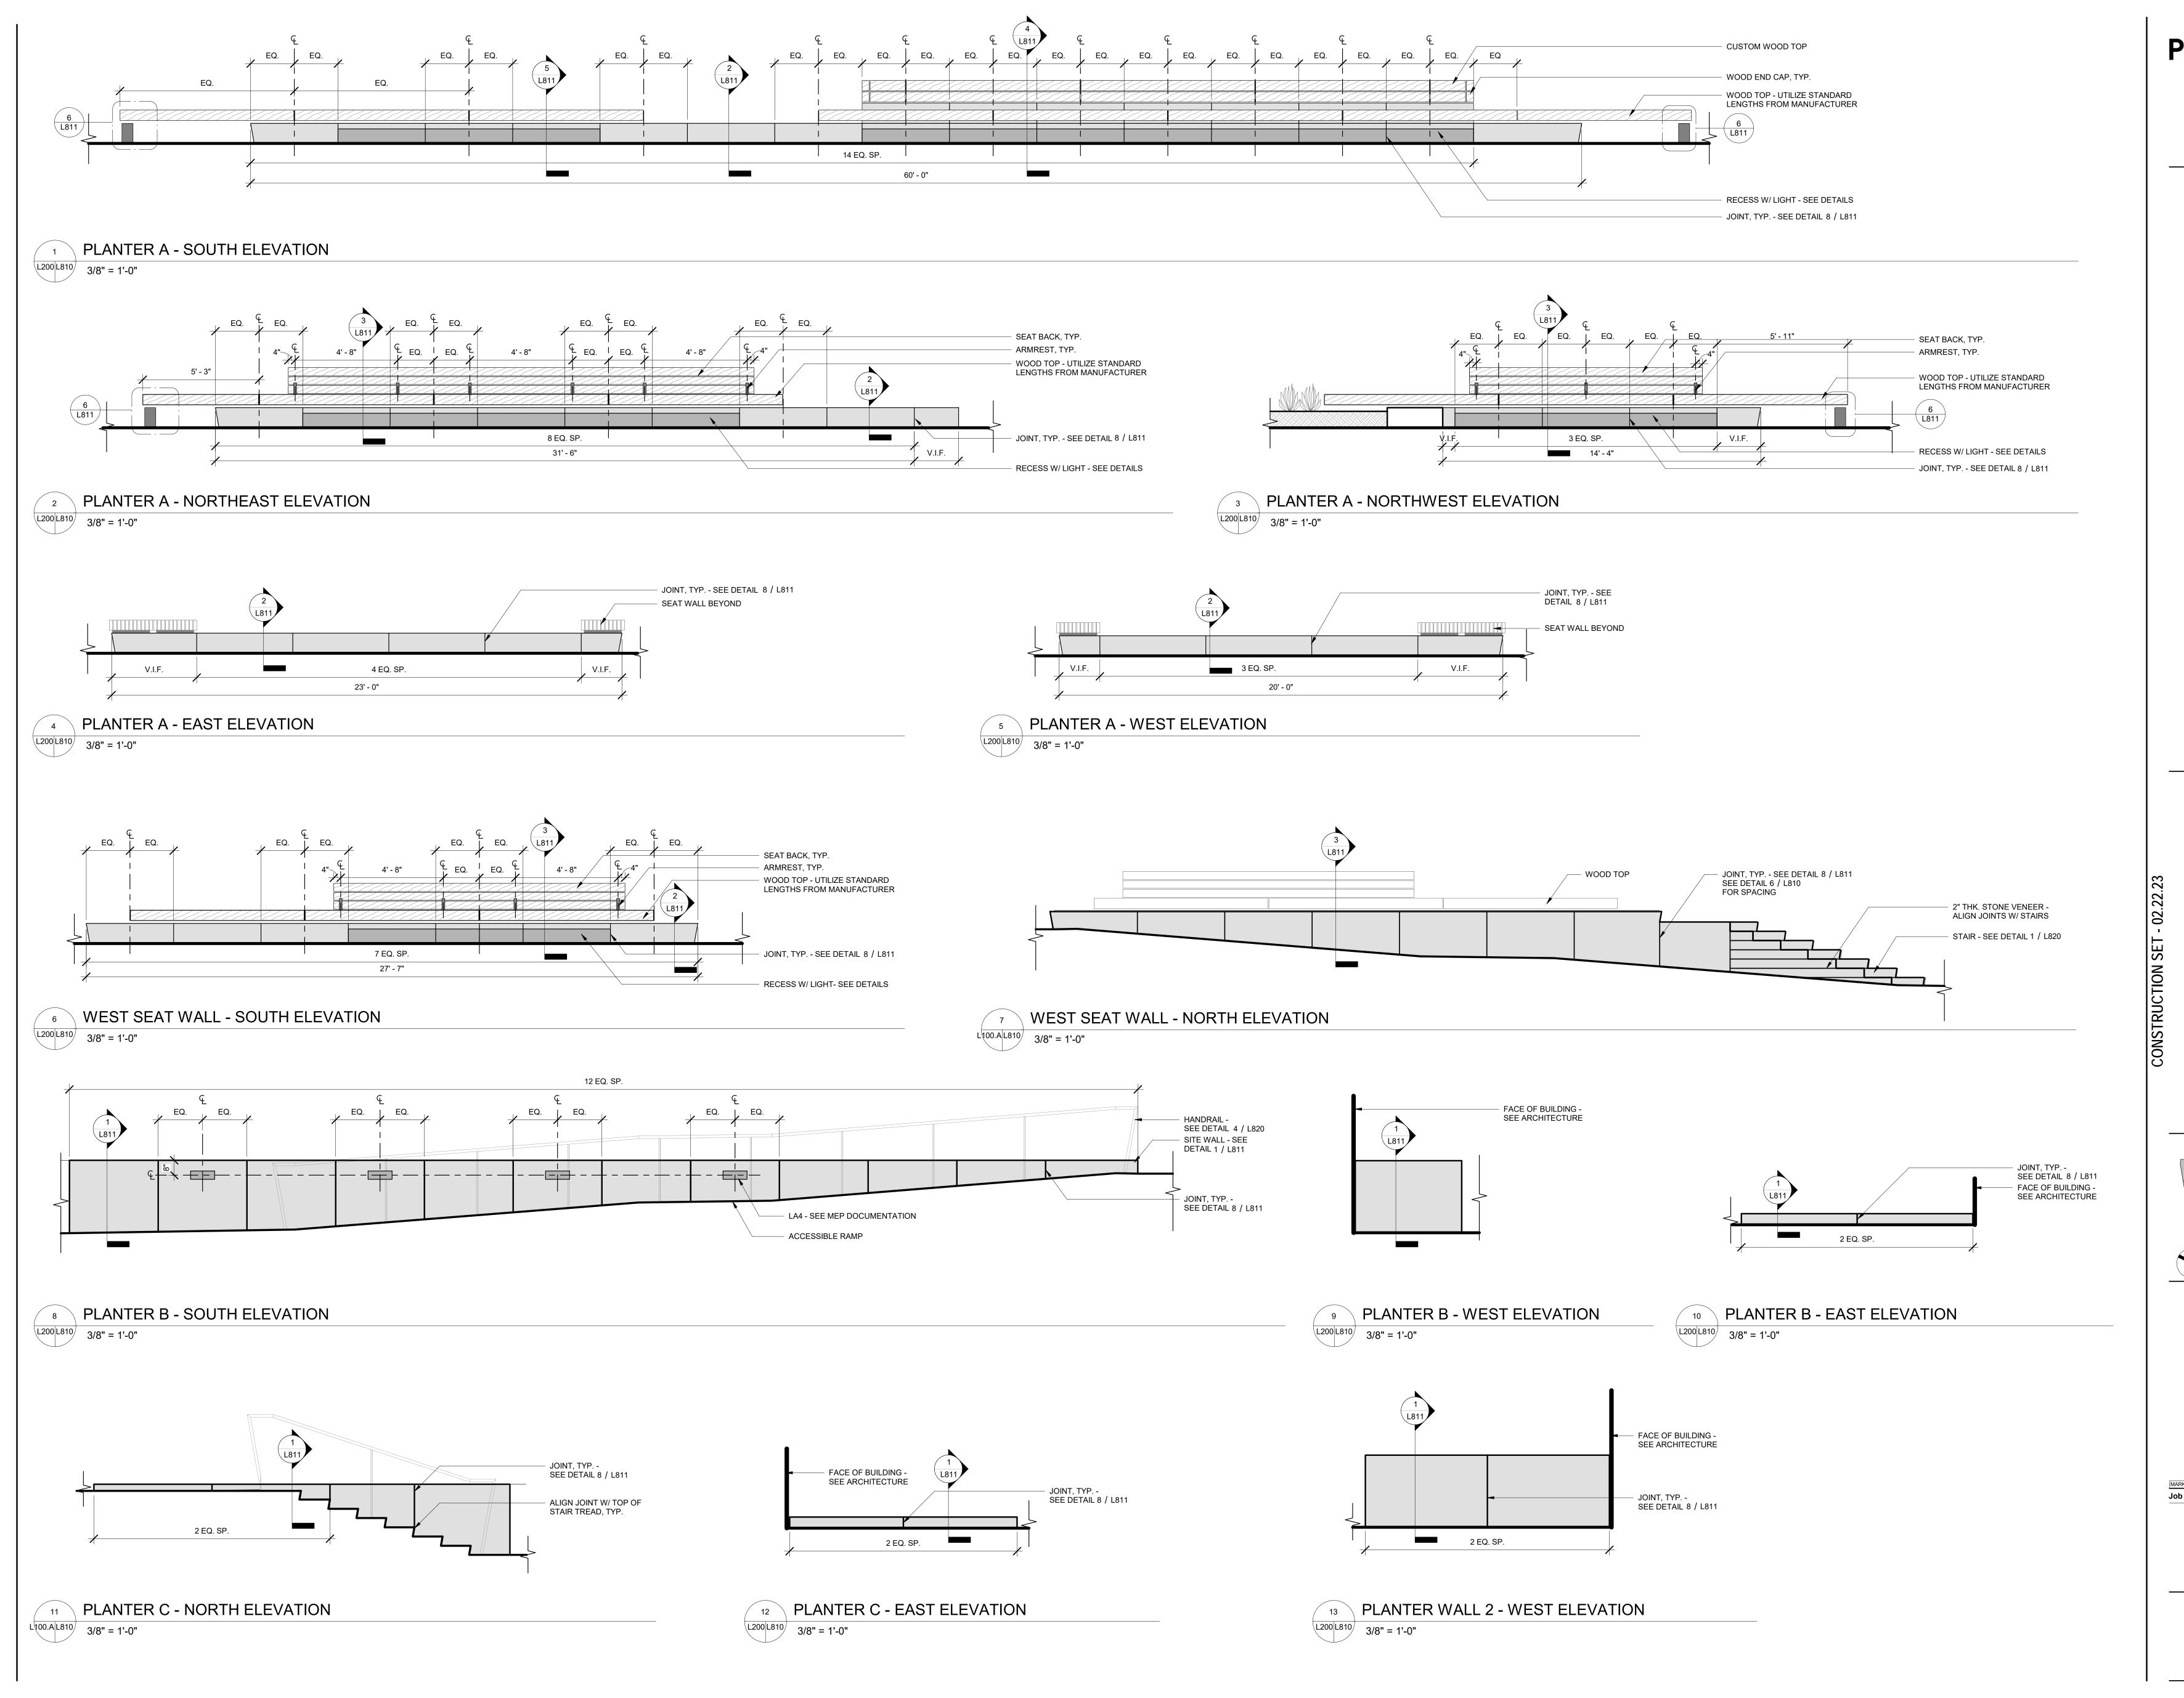

225 Franklin Street, Suite 1100 Boston, MA 02110 t 617.478.0300 f 617.478.0321 www.perkinswill.com

Jensen Hughes
One Lincoln Street
Boston, MA 02111
t 1-508-273-8481

CIVIL Bohler Engineers 45 Franklin Street Boston, MA 02110

t 617-478-0300

LANDSCAPE ARCHITECT
PERKINS&WILL
225 Franklin Street, Suite 1100
Boston, MA 02110
t 617.478.0300
f 617.478.0321

LANDSCAPE CONSULTANT MCLV
524 Walnut St. #330
Kansas City, MO 64106

sustainability consultant The Green Engineer

t816-945-4119

23 Bradford Street Concord, MA 01742 t 978-341-5462

STRUCTURAL
RFS Engineering
50 Milk Street
Boston, MA 02109
t 617-494-1464

MEP/FP RFS Engineering 50 Milk Street Boston, MA 02109 t 617-494-1464

PROJECT



Davis Square Plaza




ASANA PARTNERS

1616 Camden Road Suite 210

KEYPLAN

Charlotte, NC 28203

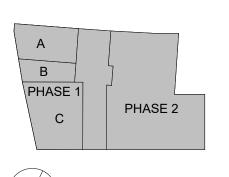

ISSUE CHART




MARK ISSUE DATE

Job Number 2206

TITLE

DETAILS - SITE WALLS - ELEVATIONS

SHEET NUMBER

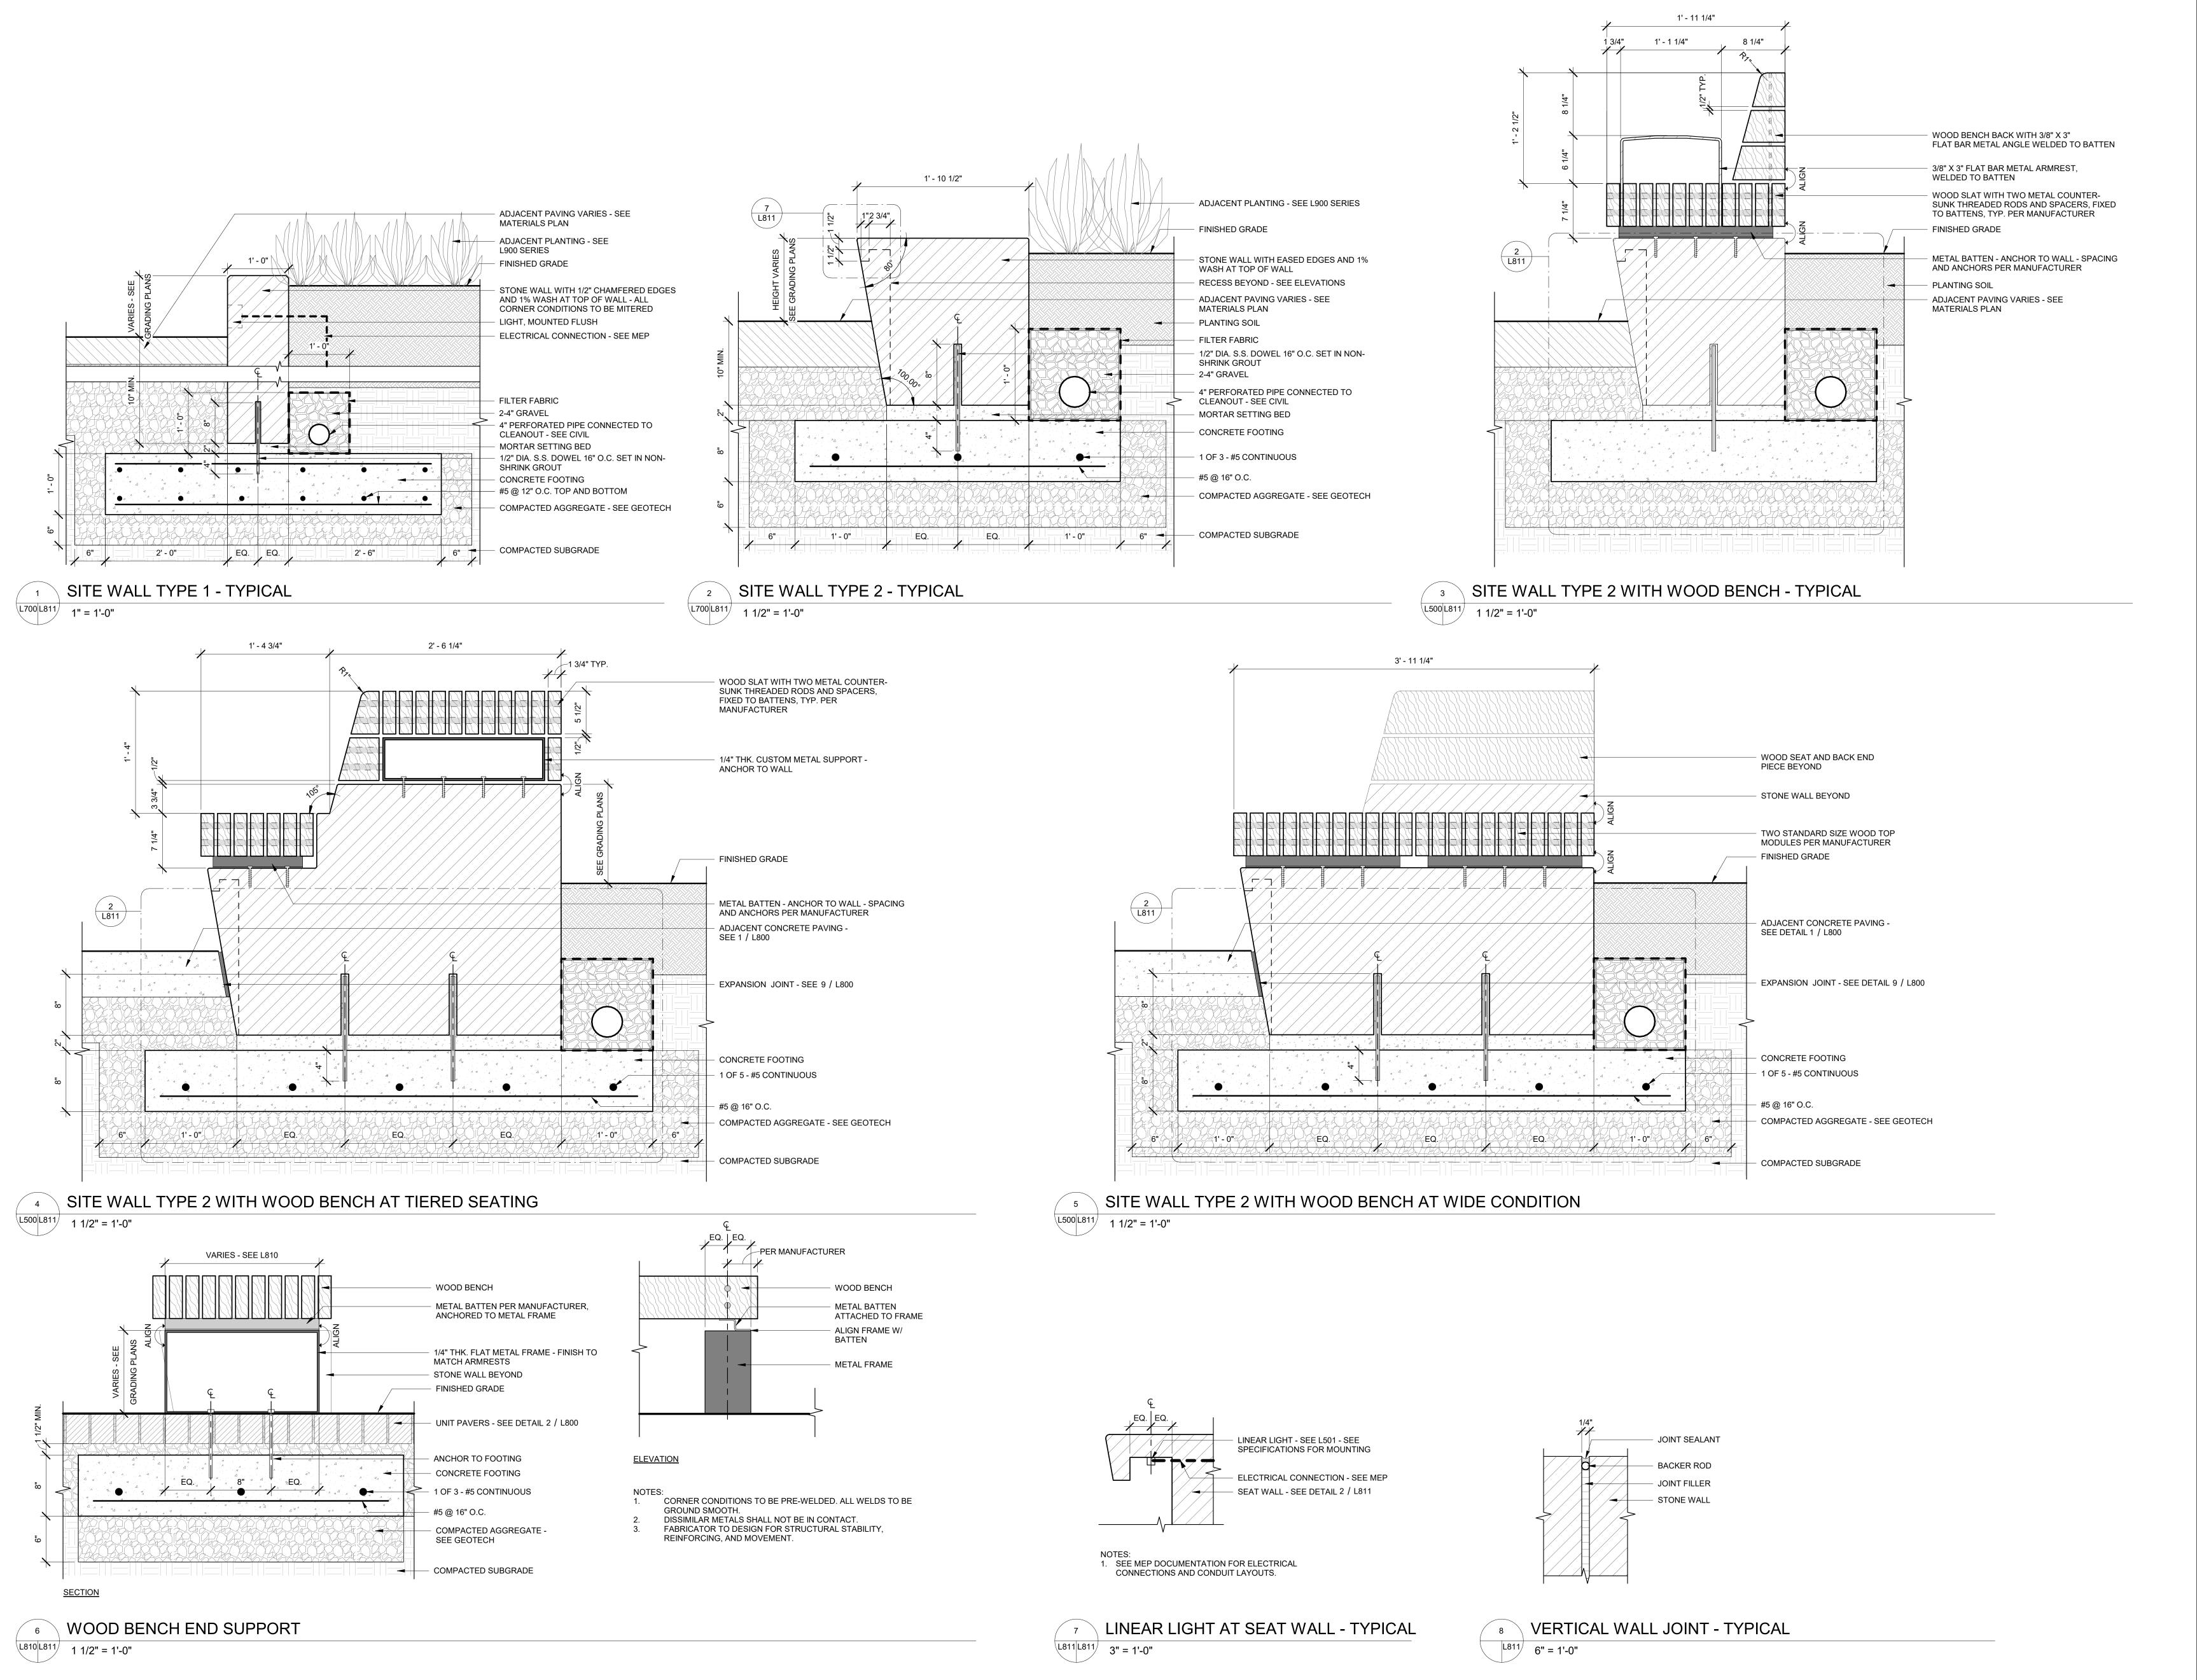

225 Franklin Street, Suite 1100 Boston, MA 02110 t 617.478.0300 f 617.478.0321 www.perkinswill.com

> Jensen Hughes One Lincoln Street Boston, MA 02111

t 1-508-273-8481

Bohler Engineers
45 Franklin Street
Boston, MA 02110
t 617-478-0300

LANDSCAPE CONSULTANT MCLV 524 Walnut St. #330 Kansas City, MO 64106

SUSTAINABILITY CONSULTANT
The Green Engineer

23 Bradford Street
Concord, MA 01742

t 978-341-5462

t 617-494-1464

t 617-494-1464

t816-945-4119

STRUCTURAL RFS Engineering 50 Milk Street Boston, MA 02109

MEP/FP RFS Engineering 50 Milk Street Boston, MA 02109

PROJECT







ASANA PARTNERS

1616 Camden Road Suite 210 Charlotte, NC 28203

KEYPLAN

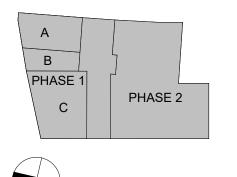

ISSUE CHART

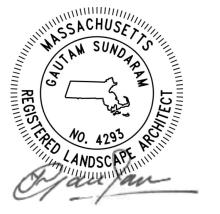


MARK ISSUE DATE

Job Number 2206

TITLE


DETAILS - SITE WALLS

SHEET NUMBER

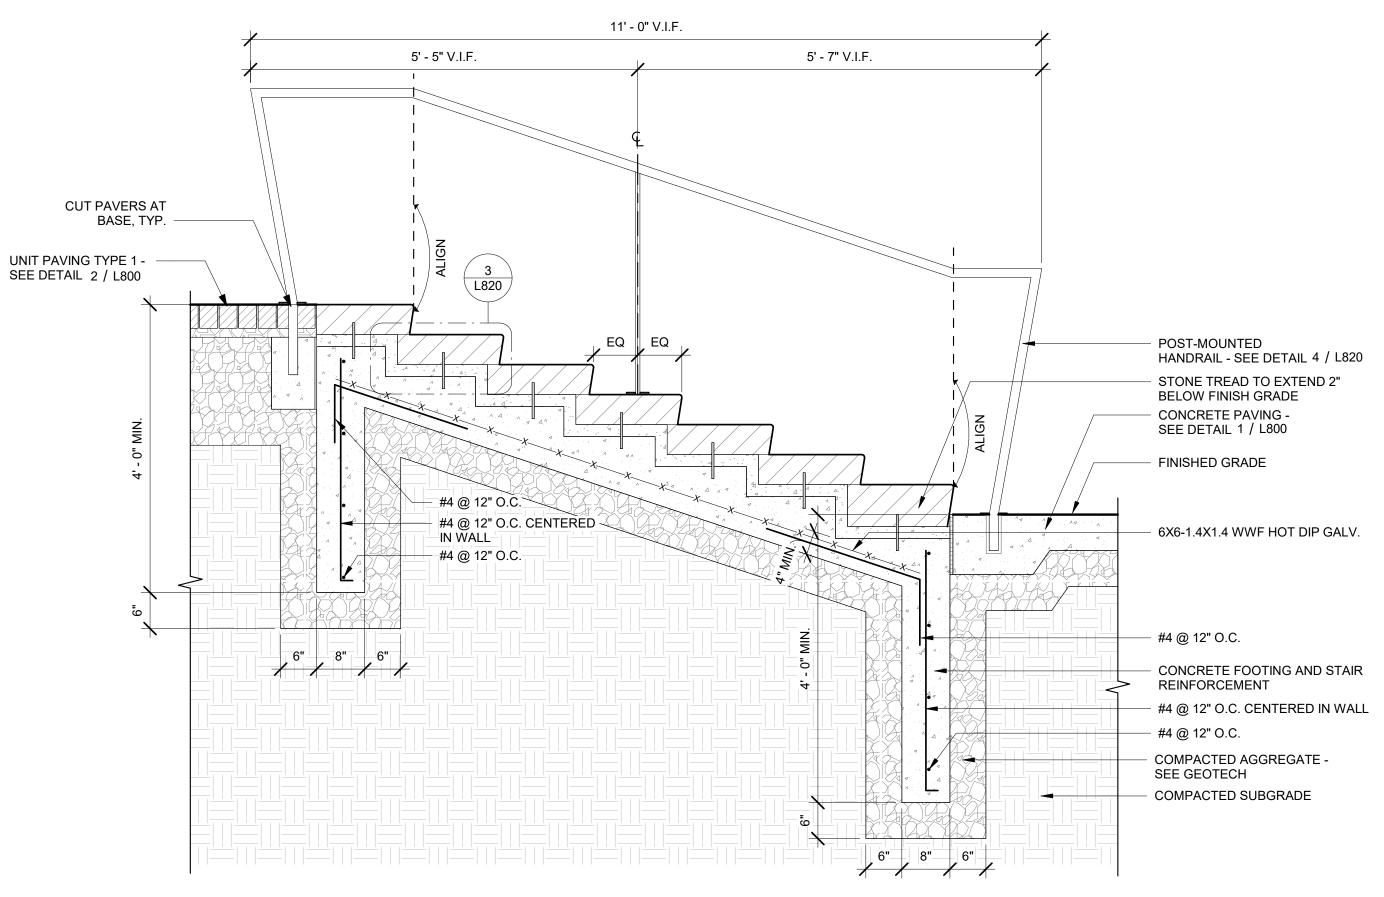


1 STAIR SECTION


L200 L820 3/4" = 1'-0"

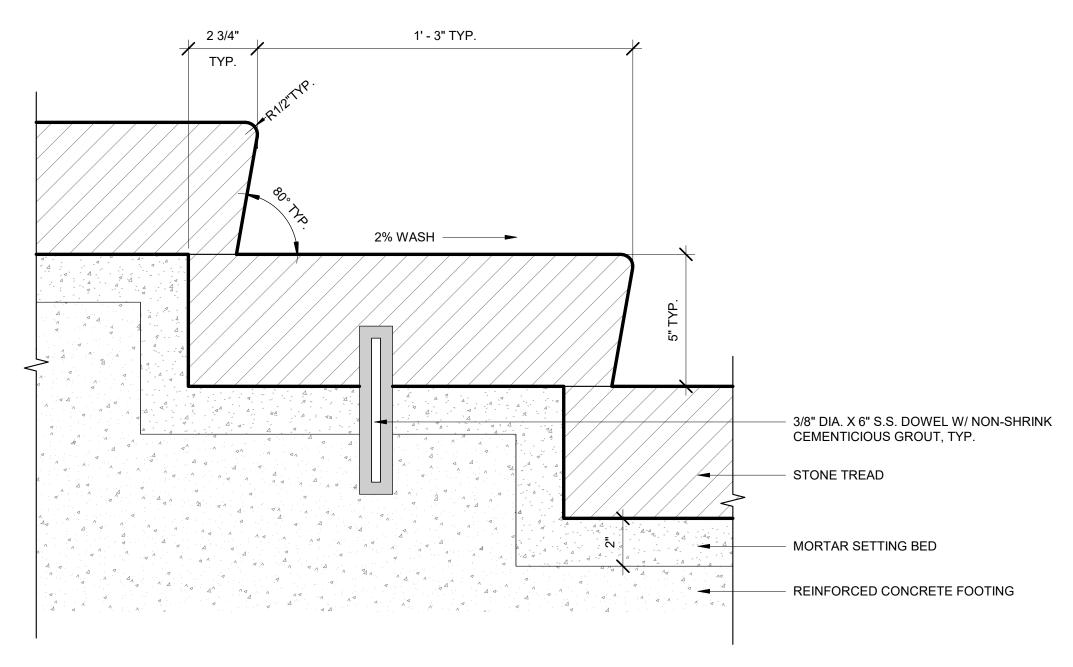

3 STAIR TREAD

L820 L820 3" = 1'-

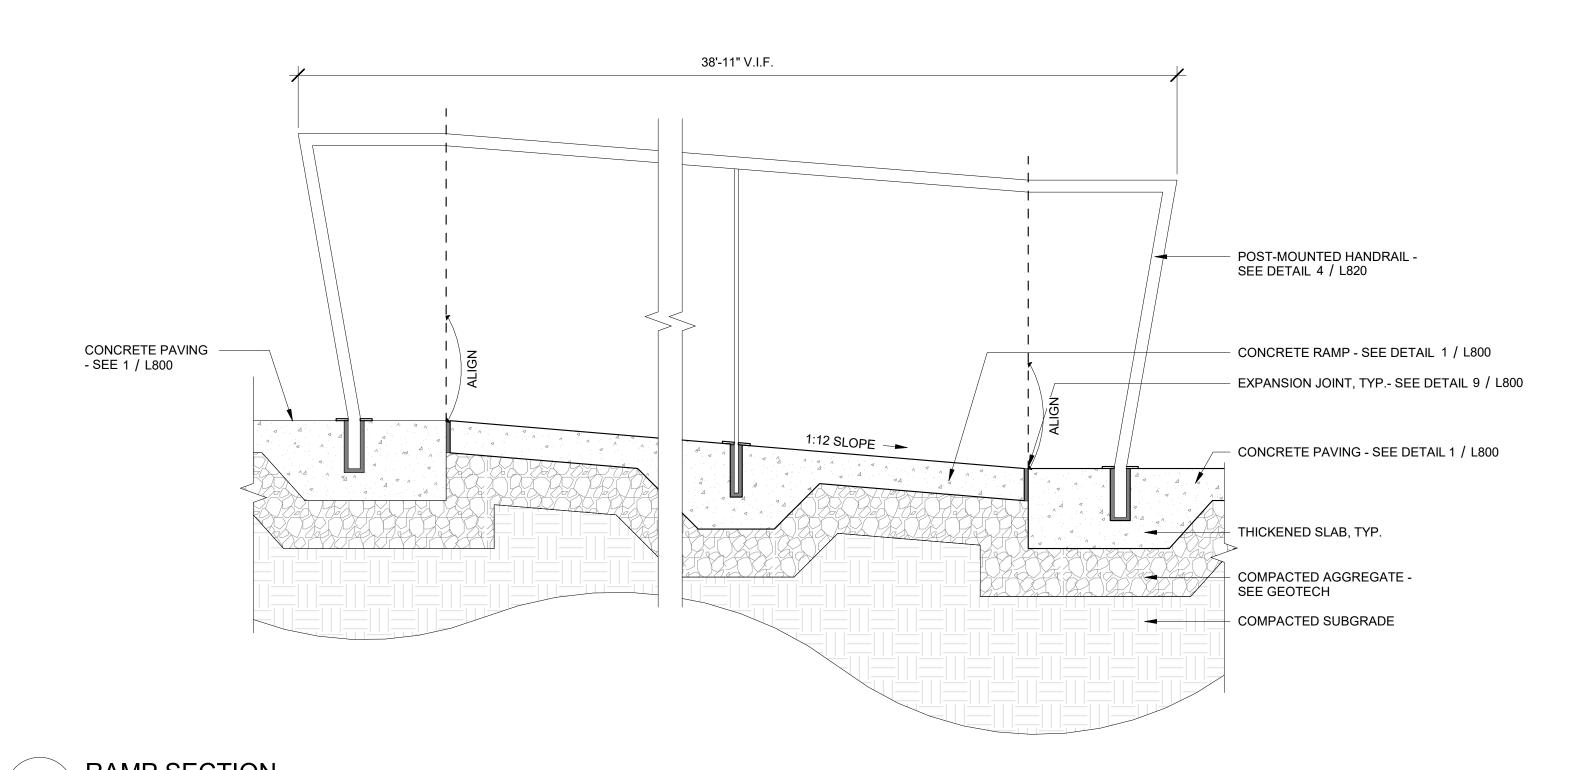

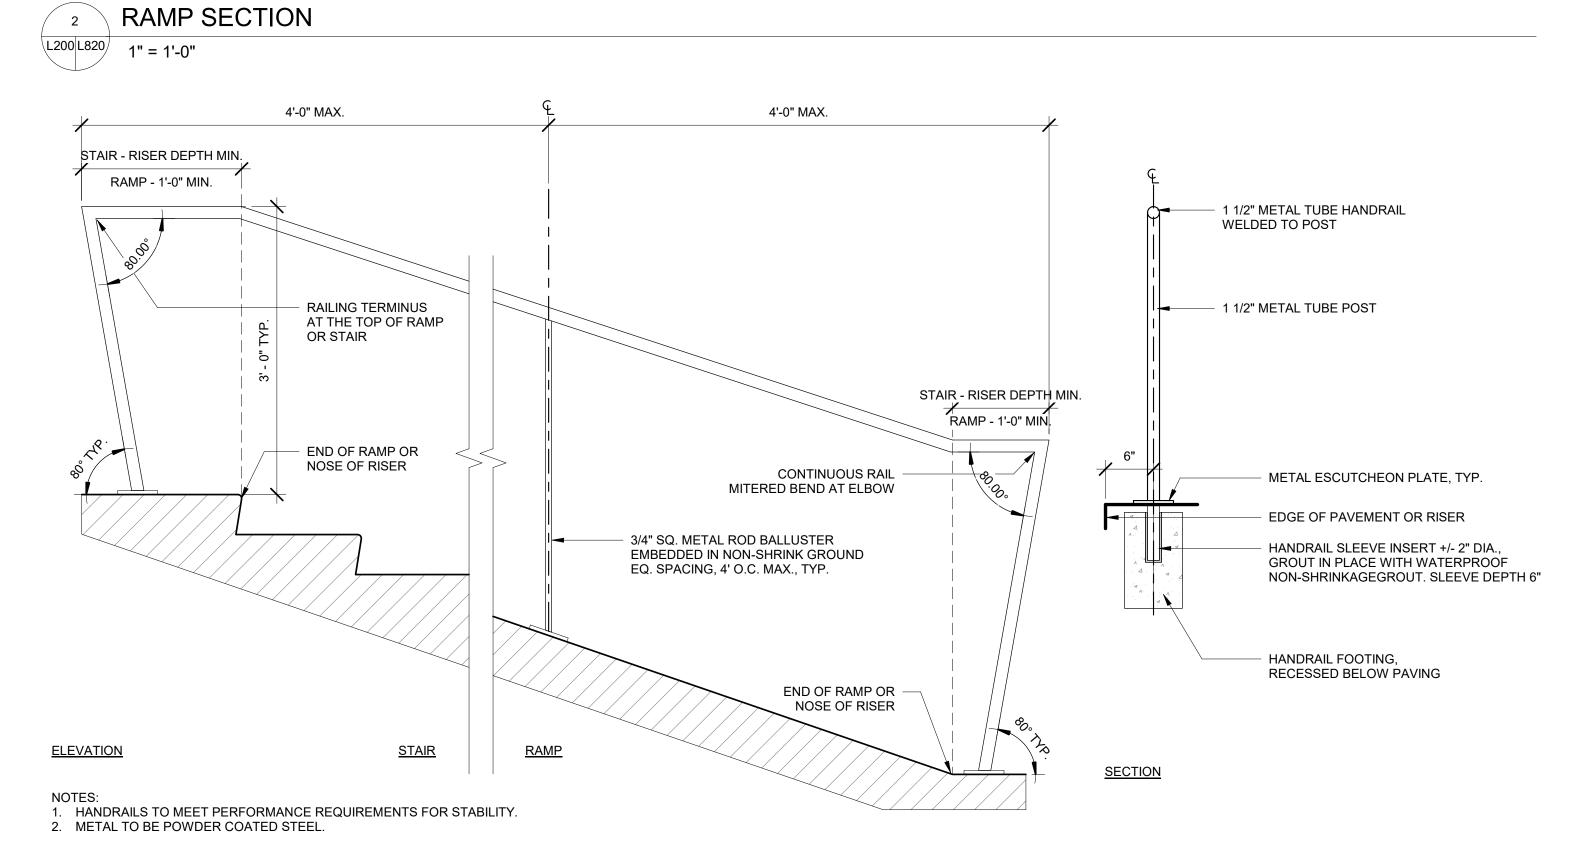

POST-MOUNTED HANDRAIL - TYPICAL

L820 1" = 1'-0"

Perkins&Will

225 Franklin Street, Suite 1100 Boston, MA 02110 t 617.478.0300 f 617.478.0321 www.perkinswill.com

Jensen Hughes
One Lincoln Street
Boston, MA 02111
t 1-508-273-8481

Bohler Engineers
45 Franklin Street
Boston, MA 02110
t 617-478-0300

LANDSCAPE ARCHITECT
PERKINS&WILL
225 Franklin Street, Suite 1100
Boston, MA 02110
t 617.478.0300
f 617.478.0321

LANDSCAPE CONSULTANT
MCLV
524 Walnut St. #330
Kansas City, MO 64106

t816-945-4119

sustainability consultant The Green Engineer 23 Bradford Street Concord, MA 01742

t 978-341-5462

STRUCTURAL

RFS Engineering

50 Milk Street

Boston, MA 02109

MEP/FP RFS Engineering 50 Milk Street Boston, MA 02109 t 617-494-1464

t 617-494-1464

PROJECT




Davis Square Plaza




ASANA PARTNERS

1616 Camden Road Suite 210 Charlotte, NC 28203

KEYPLAN

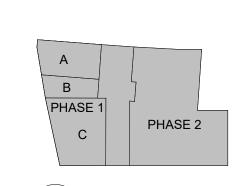



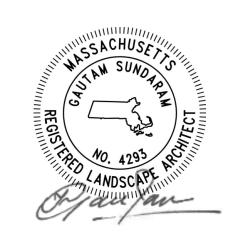


Job Number 2200
TITLI

DETAILS - SITE STAIRS / RAMPS

SHEET NUMBER

BICYCLE RACK - TYPICAL

L830 1" = 1'-0"

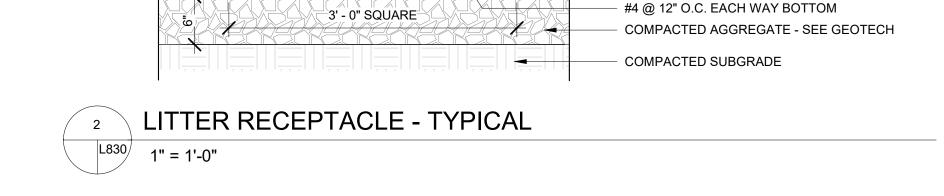

- LITTER RECEPTACLE


UNIT PAVERS - SEE DETAIL 2 / L800

- CHEMICALLY ANCHOR PER MANUFACTURER'S

- ANCHORS PER MANUFACTURER

WRITTEN RECOMMENDATIONS

CONCRETE FOOTING

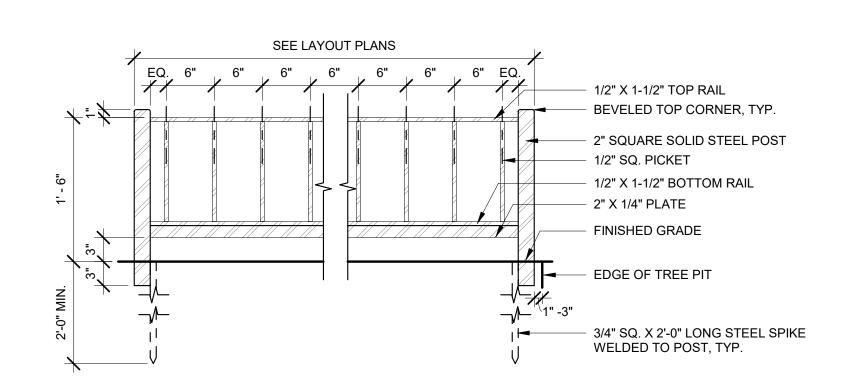


COATS OF PAINT, PER SPECIFICATIONS


ALL COMPONENTS SOLID STEEL WITH THREE SHOP APPLIED


TREE GUARD - TYPICAL ELEVATION

1" = 1'-0"

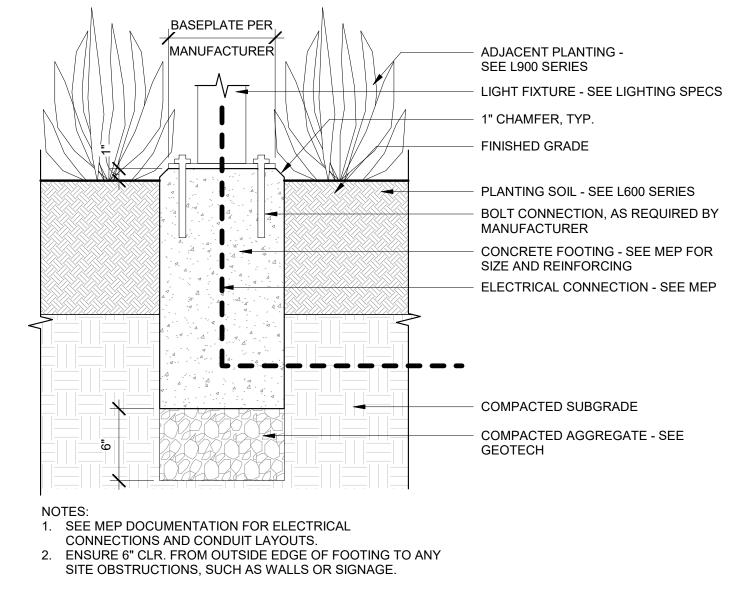




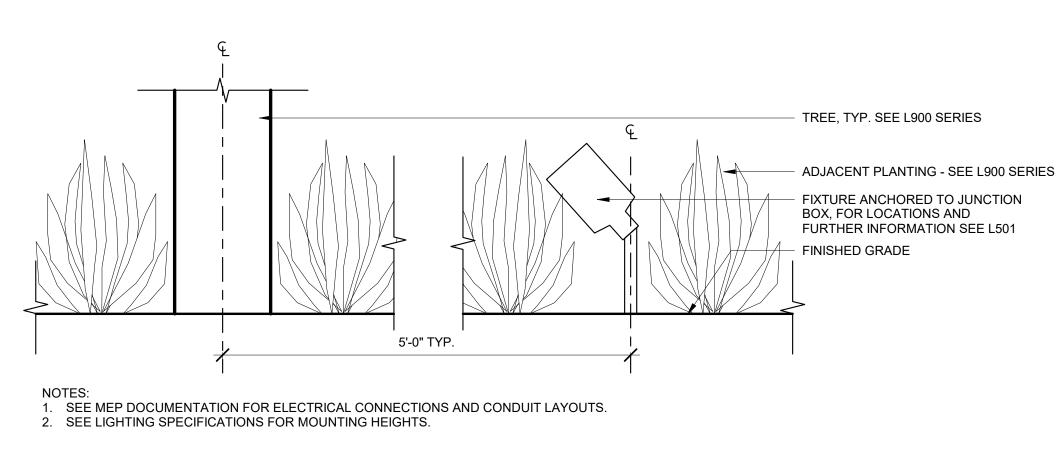

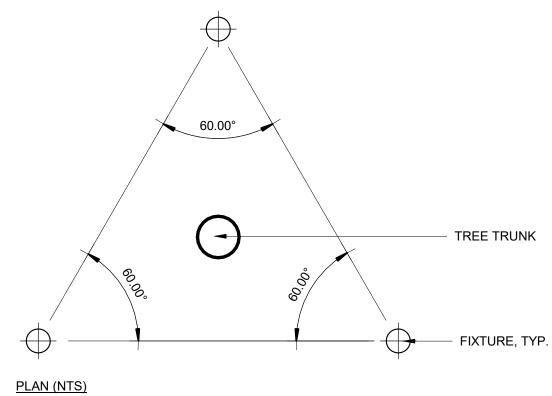

TREE ACCENT LIGHT

L830 1 1/2" = 1'-0"

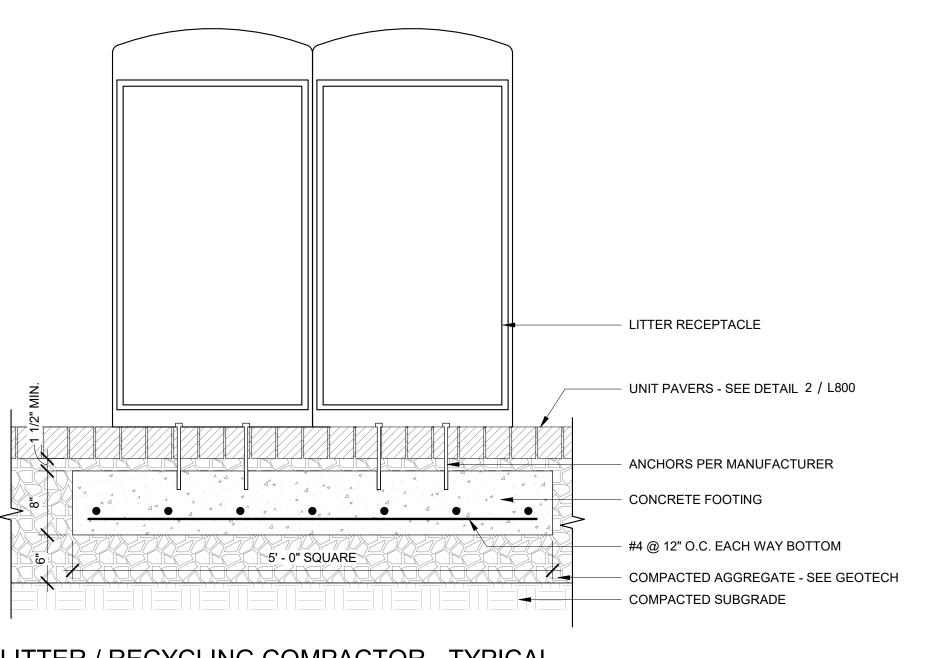

RECEPTACLE BOLLARD SEE SPECIFICATIONS

ADJACENT PLANTING SEE L900 SERIES

FINISHED GRADE

PLANTING SOIL SEE L600 SERIES

COMPACTED SUBGRADE

NOTES:

1. SEE MEP DOCUMENTATION FOR ELECTRICAL
CONNECTIONS AND CONDUIT LAYOUTS.

2. ENSURE 18" CLR. FROM RECEPTACLE BOLLARD TO ANY
SITE OBSTRUCTIONS, SUCH AS WALLS OR TREES.

6 RECEPTACLE BOLLARD IN PLANTING

1 1/2" = 1'-0"

Perkins&Will

225 Franklin Street, Suite 1100 Boston, MA 02110 t 617.478.0300 f 617.478.0321 www.perkinswill.com

Jensen Hughes
One Lincoln Street
Boston, MA 02111
t 1-508-273-8481

Bohler Engineers 45 Franklin Street Boston, MA 02110 t 617-478-0300

LANDSCAPE ARCHITECT
PERKINS&WILL
225 Franklin Street, Suite 1100
Boston, MA 02110
t 617.478.0300
f 617.478.0321

LANDSCAPE CONSULTANT
MCLV
524 Walnut St. #330
Kansas City, MO 64106

t816-945-4119

t 978-341-5462

SUSTAINABILITY CONSULTANT
The Green Engineer
23 Bradford Street
Concord, MA 01742

STRUCTURAL RFS Engineering 50 Milk Street Boston, MA 02109 t 617-494-1464

MEP/FP RFS Engineering 50 Milk Street Boston, MA 02109 t 617-494-1464

PROJECT



Davis Square Plaza


(0)

ASANA PARTNERS


1616 Camden Road Suite 210

KEYPLAN

Charlotte, NC 28203

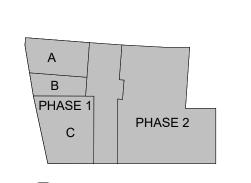




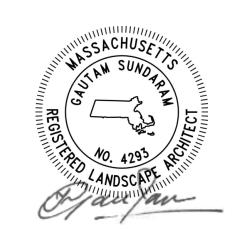

Job Number 2206

DETAILS - SITE FURNISHINGS

SHEET NUMBER

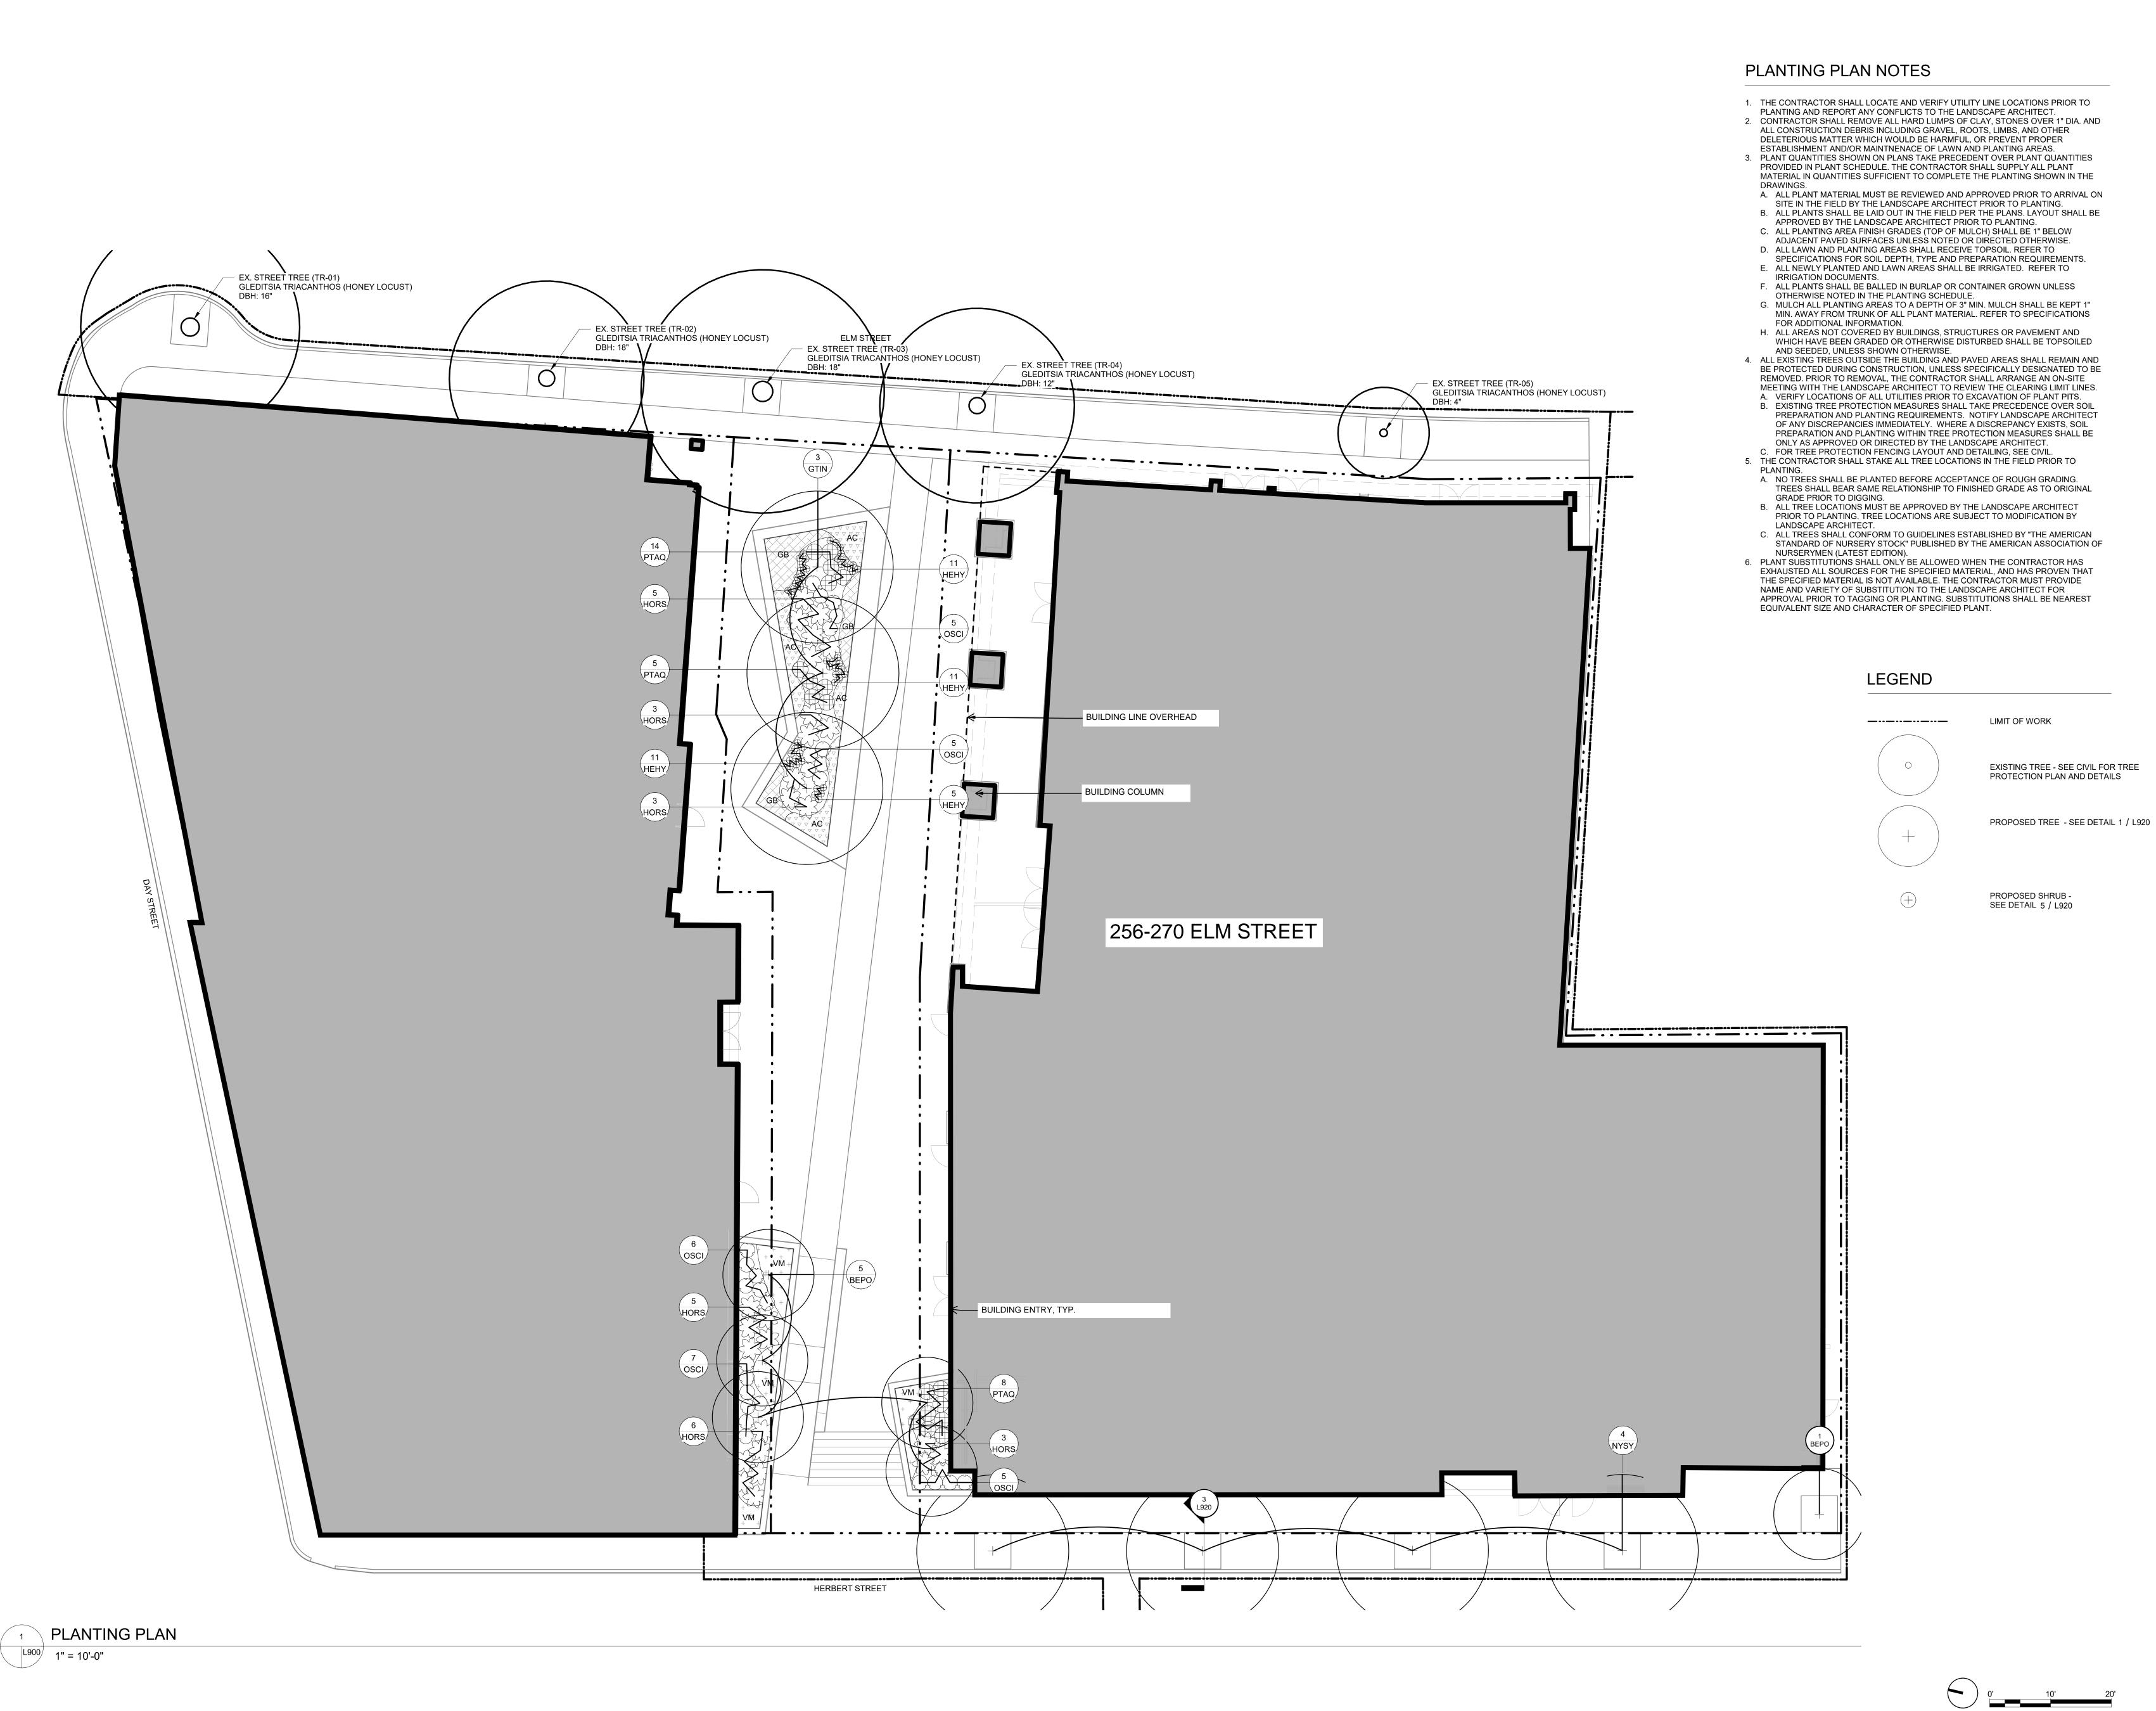

225 Franklin Street, Suite 1100 Boston, MA 02110 t 617.478.0300 f 617.478.0321 www.perkinswill.com

> Jensen Hughes One Lincoln Street Boston, MA 02111 t 1-508-273-8481

Bohler Engineers 45 Franklin Street Boston, MA 02110 t 617-478-0300

LANDSCAPE ARCHITECT PERKINS&WILL 225 Franklin Street, Suite 1100 Boston, MA 02110 t 617.478.0300

f 617.478.0321 LANDSCAPE CONSULTANT MCLV

524 Walnut St. #330 Kansas City, MO 64106 t816-945-4119

SUSTAINABILITY CONSULTANT The Green Engineer 23 Bradford Street Concord, MA 01742

t 978-341-5462 STRUCTURAL RFS Engineering 50 Milk Street

t 617-494-1464 RFS Engineering 50 Milk Street

Boston, MA 02109

t 617-494-1464

Boston, MA 02109

PROJECT







ASANA PARTNERS **ASANA PARTNERS**

1616 Camden Road Suite 210 Charlotte, NC 28203

KEYPLAN

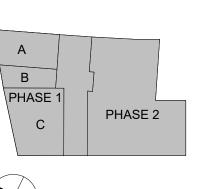

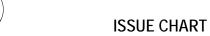




TITLE

PLANTING PLAN

SHEET NUMBER

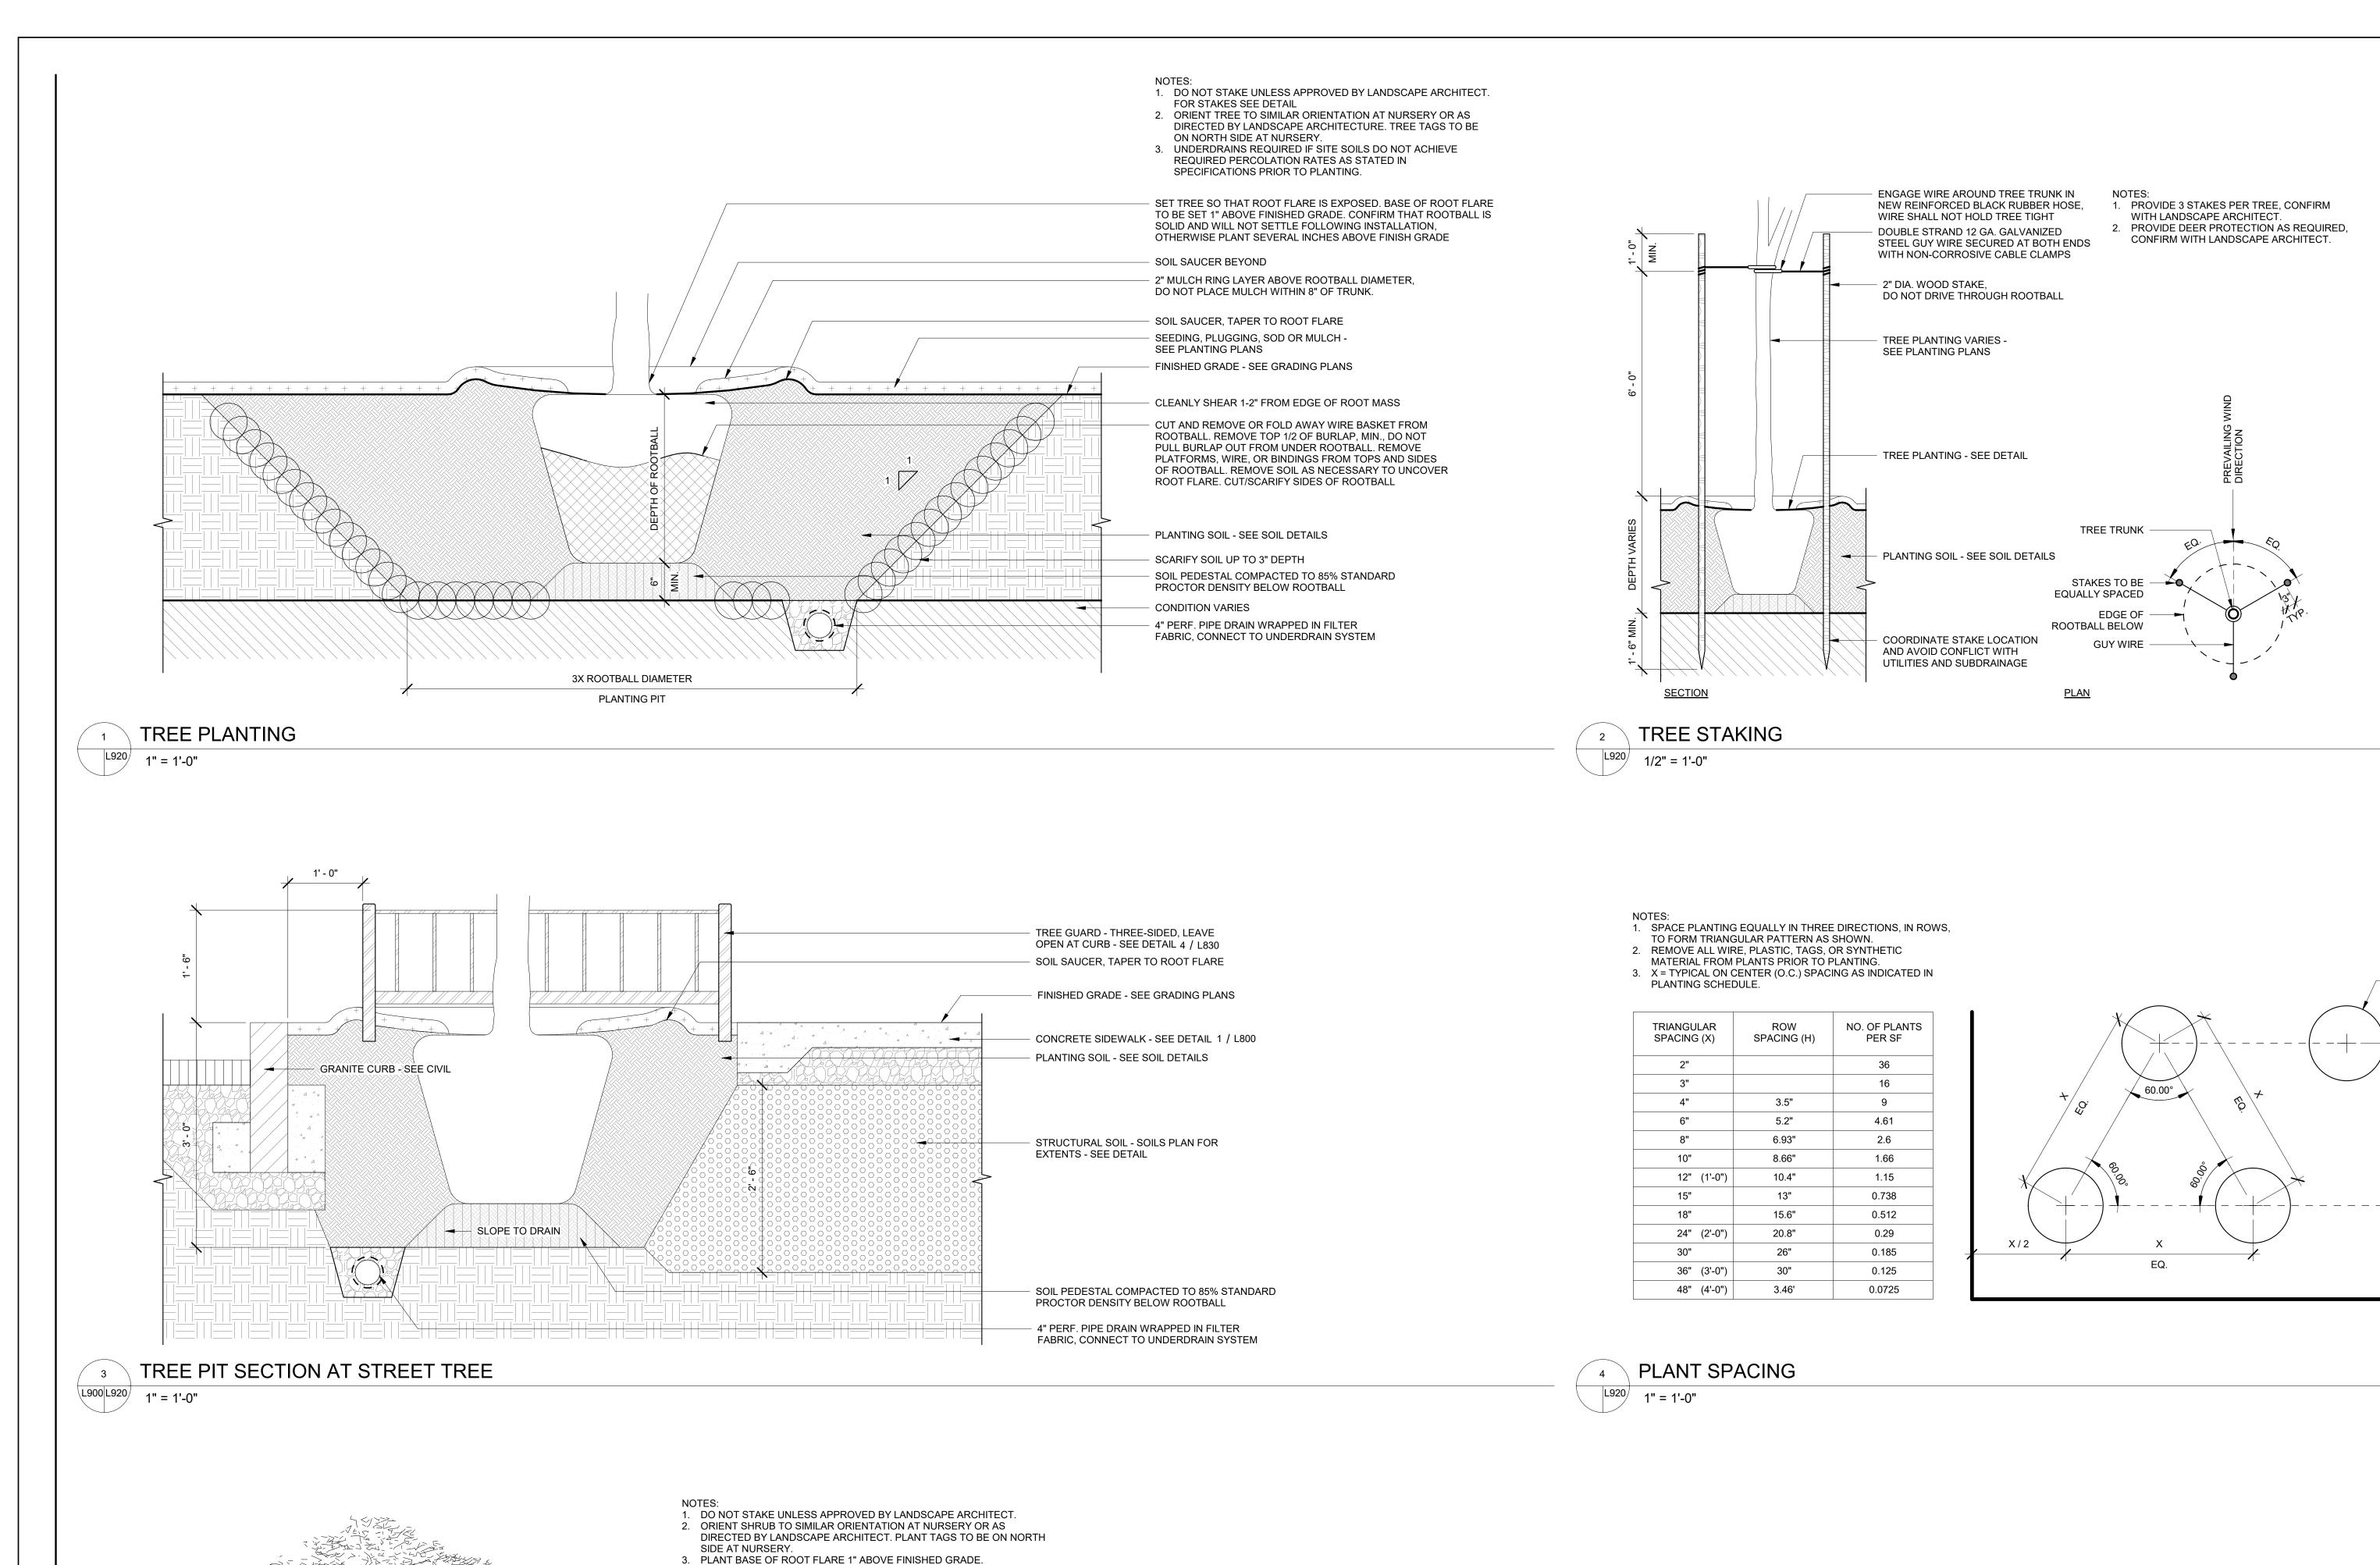

ONLY PRUNE BROKEN, DEAD, CROSSED, OR RUBBING BRANCHES AS DIRECTED BY LANDSCAPE ARCHITECT

2" MULCH RING LAYER ABOVE ROOTBALL DIAMETER, DO

SEEDING, PLUGGING, SOD OR MULCH - SEE PLANTING PLANS

CUT AND REMOVE WIRE BASKET FROM ROOTBALL. REMOVE

CONTAINER, REMOVE MOST OF BURLAP, DO NOT PULL BURLAP OUT FROM UNDER ROOTBALL. REMOVE PLATFORMS, WIRE, OR BINDINGS FROM TOPS AND SIDES OF ROOTBALL.

COMPACTED PEDESTAL TO SUPPORT ROOTBALL AND

TEMPORARY SOIL SAUCER, TAPER TO ROOT FLARE

NOT PLACE MULCH WITHIN 3" OF TRUNK.

FINISHED GRADE - SEE GRADING PLANS


CUT/SCARIFY SIDES OF ROOTBALL.

PLANTING SOIL - SEE SOIL DETAILSSCARIFY SOIL UP TO 3" DEPTH

PREVENT SETTLING

— CONDITION VARIES

SAUCER BEYOND

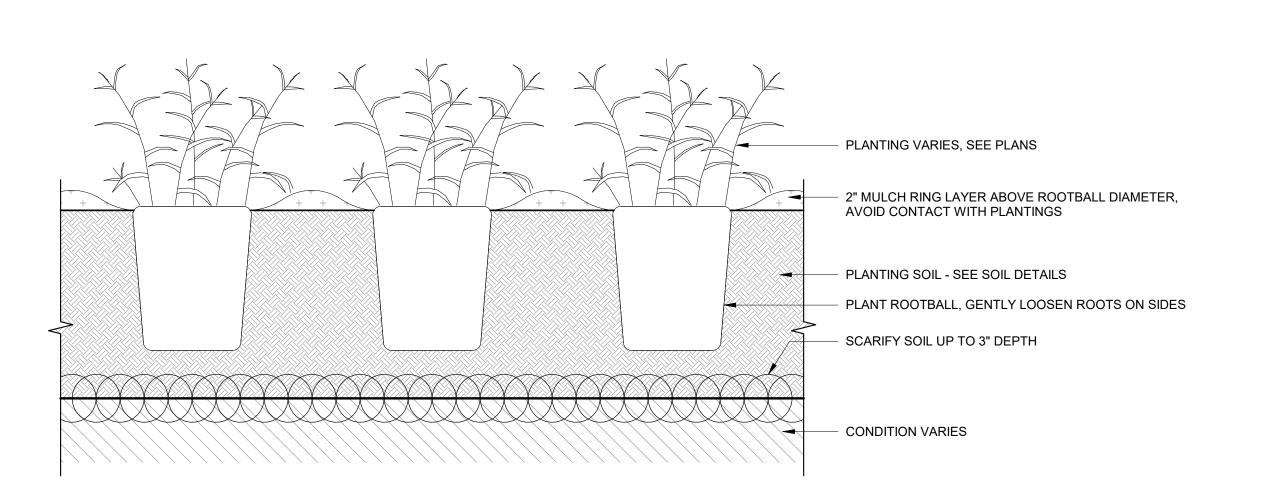

GROUNDCOVER, PERENNIAL, AND GRASSES PLANTING

L920 1" = 1'-0"

Perkins&Will

225 Franklin Street, Suite 1100 Boston, MA 02110 t 617.478.0300 f 617.478.0321 www.perkinswill.com

Jensen Hughes
One Lincoln Street
Boston, MA 02111
t 1-508-273-8481

CIVIL Bohler Engineers 45 Franklin Street Boston, MA 02110

t 617-478-0300

t816-945-4119

t 978-341-5462

t 617-494-1464

LANDSCAPE CONSULTANT MCLV 524 Walnut St. #330 Kansas City, MO 64106

sustainability consultant The Green Engineer 23 Bradford Street Concord, MA 01742

STRUCTURAL
RFS Engineering
50 Milk Street
Boston, MA 02109

RFS Engineering
50 Milk Street
Boston, MA 02109
t 617-494-1464

PROJECT



Davis Square Plaza

PLANT, SEE PLANS TYP.

EDGE OF PLANTING AREA

(3)

ASANA PARTNERS

1616 Camden Road Suite 210

Charlotte, NC 28203

KEYPLAN

A
B
PHASE 1
C
PHASE 2

ISSUE CHART



MARKISSUEDATEJob Number2206TITLE

DETAILS - PLANTING

SHEET NUMBER


L920

9:01 AM BIM 360://Asana Partners - Davis Square Plaza/LAND_2206-Davis-Squar

L920 1" = 1'-0"

5 SHRUB PLANTING

2X ROOTBALL DIAMETER
PLANTING PIT

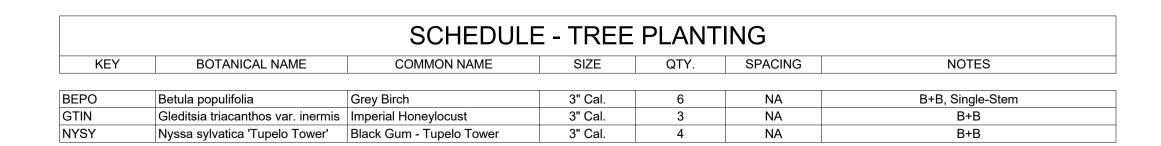

SCHEDULE - UNDERSTORY PLANTING						
KEY	BOTANICAL NAME	COMMON NAME	SIZE	QTY.	SPACING	NOTES
HEHY	Helleborus x hybridus	Hybrid Hellebores	#1	52	AS SHOWN	
HORS	Hosta 'Royal Standard'	Royal Standard Hosta	#2	26	AS SHOWN	
OSCI	Osmunda cinnamomea	Cinnamon Fern	#2	28	AS SHOWN	
PTAQ	Pteridium aquilinum	Bracken Fern	#2	18	AS SHOWN	

SCHEDULE - GROUNDCOVER PLANTING						
KEY	BOTANICAL NAME	COMMON NAME	SIZE	QTY.	SPACING	NOTES
AC	Asarum canadense	Canadian Wild Ginger	4" POT	144	12" O.C.	APPROX. QUANTITIES PROVIDED
GB	Gaylussacia baccata	Black Huckleberry	4" POT	122	12" O.C.	APPROX. QUANTITIES PROVIDED
VM	Vinca minor	Periwinkle	4" POT	148	12" O.C.	APPROX. QUANTITIES PROVIDED

225 Franklin Street, Suite 1100 Boston, MA 02110 t 617.478.0300 f 617.478.0321 www.perkinswill.com

Jensen Hughes
One Lincoln Street
Boston, MA 02111
t 1-508-273-8481

Bohler Engineers 45 Franklin Street Boston, MA 02110 t 617-478-0300

LANDSCAPE CONSULTANT MCLV 524 Walnut St. #330 Kansas City, MO 64106 t816-945-4119

sustainability consultant The Green Engineer 23 Bradford Street Concord, MA 01742 t 978-341-5462

RFS Engineering
50 Milk Street
Boston, MA 02109
t 617-494-1464

MEP/FP RFS Engineering 50 Milk Street Boston, MA 02109 t 617-494-1464

PROJECT




Davis Square Plaza

(0)

ASANA
PARTNERS

1616 Camden Road Suite 210 Charlotte, NC 28203

KEYPLAN

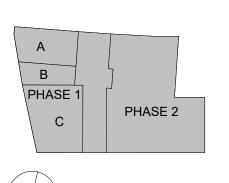

ISSUE CHART



Job Number 2206

PLANTING SCHEDULE

SHEET NUMBER